
RANGER

CONSTRUCTION UPDATE

DECEMBER 2021

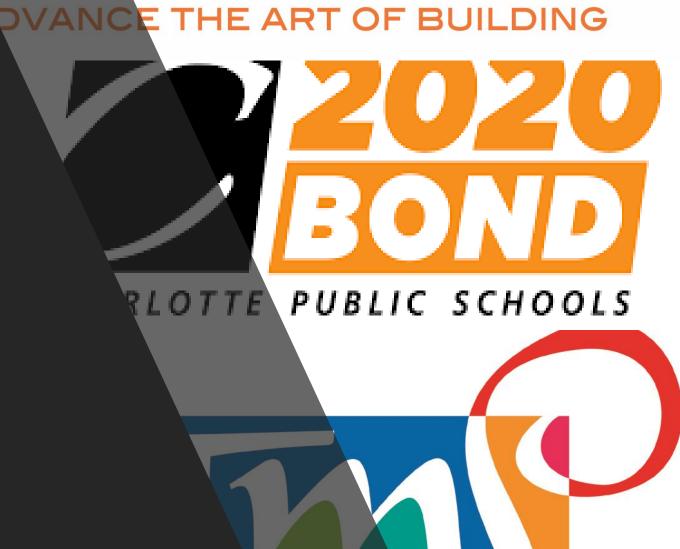



Weymouth ECC Renovation





Work In Progress:

Punch List

Upcoming work:

• Substantially Complete



New Vertical Unit Ventilator in room 106



Tennis Courts & Concession Building





Work In Progress:

- Pass Through Window
- Winterization
- Final Electrical Inspection
- Punch List Completion


Upcoming work:

Rolling Coil Door Installation







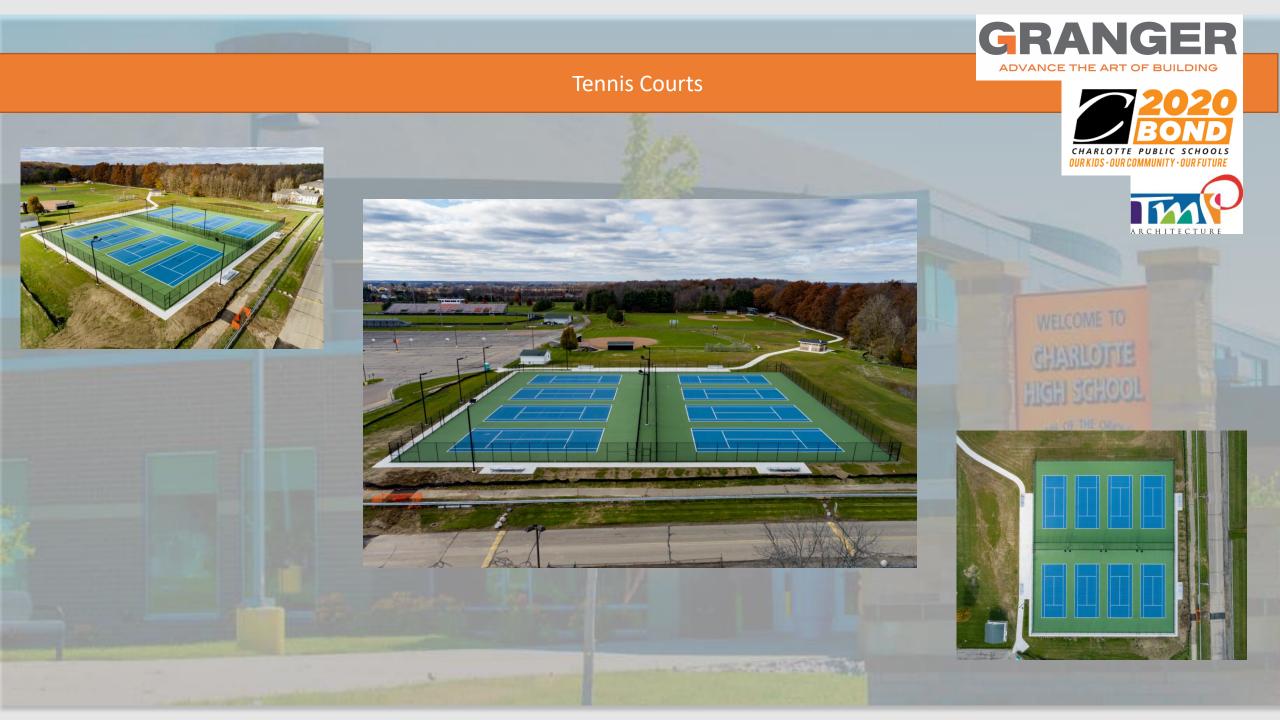



Agricultural Learning Center





Work In Progress:

- Water & Sanitary Lines
- Lean to Rafters
- Roof Sheathing
- Underground Plumbing
- Underground Electrical

Upcoming work:

- Prep & Place Concrete Slab
- Restore Sidewalk
- Roofing
- Masonry
- Exterior Wall Framing









Phase 2: Design Development Plan Documents



CPS 2020Bond Program Phase II Drawings

Galewood Elementary

SITE BM#100 SOUTHWEST BOLT ON HYDRANT, LOCATED +/_75' NORTH
OF NORTHEAST BUILDING CORNER & +/-22' SOUTH OF

CENTERLINE OF E LOVETT ST.

ELEV.=894.89

SITE BM#101 CHISELED "+" ON NORTH RIM OF ROUND CATCH BASIN (STR #2) LOCATED IN ASPH PARKING LOT+/-40' EAST OF EAST BUILDING FACE & +/-44' WEST OF EDGE OF ASPH.

ELEV.=892.98

SITE BM#102 CHISLED "+" ON NORTH RIM OF ROUND CATCH BASIN (STR. #5) LOCATED IN ASPH PLAYGROPUND +/-18' WEST OF WEST BUILDING FACE & +/-32' NE OF EDGE OF ASPH ELEV.=894.93

SITE IMPROVEMENT LEGEND

STANDARD HMA PAVEMENT

HEAVY DUTY HMA PAVEMENT

CONCRETE SIDEWALK

LAWN/LANDSCAPE AREA

LANDSCAPE MULCH

SITE IMPROVEMENT KEY

6 THICKENED EDGE SIDEWALK TO MATCH EXISTING

7 TYPE P ADA RAMP

C-501

SITE IMPROVEMENT NOTES

4. REFER TO SHEET C-104 FOR SITE GRADING DESIGN.

5. REFER TO SHEET C-105 FOR SITE UTILITY DESIGN.

PROPOSED PAVEMENT (SIDEWALKS AND PAD): 8,600 SF

PROPOSED MULCH SURFACE (NOT TO BE USED AS PLAY SURFACE): 6,400 SF

PARKING

PROPOSED PARKING SPACES: 41 REQUIRED ADA SPACES: 2

COURTYARD

 ALL AREAS SHOWN NOT BUILT, PAVED OR OTHERWISE COVERED BY CONSTRUCTION SHALL BE HYDROMULCH SEEDED, REFER TO SPECS FOR DETAILS.

2. ALL AREAS DISTURBED BY CONSTRUCTION WHICH ARE OUTSIDE THE CONSTRUCTION LIMITS SHALL BE RESTORED TO A CONDITION EQUAL TO, OR BETTER THAN EXISTING CONDITIONS.

3. THE SITE CONTRACTOR SHALL COORDINATE WORK WITH ALL ADJACENT CONSTRUCTION BY OTHERS.

2 CONNECT PROPOSED FIRE SERVICE TO EX WATER MAIN. COORDINATE CONNECTION
WITH CITY OF CHARLOTTE
MDOT TYPE-M DRIVEWAY OPENING.

8
(C-502)

1) RELOCATED LIGHT POLE

4 DO NOT ENTER SIGN

5 SEGMENTED BLOCK WALL -

— CONSTRUCTION LIMITS

_____ FIRE PROTECTION WATER LINE

architecture

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PROJECT TITLE


Galewood Elementary School Additions and Renovations

CHARLOTTE PUBLIC SCHOOLS CHARLOTTE, MI

DRAWING TITLE

SITE IMPROVEMENTS
AND GEOMETRICS PLAN

KEYPLAN

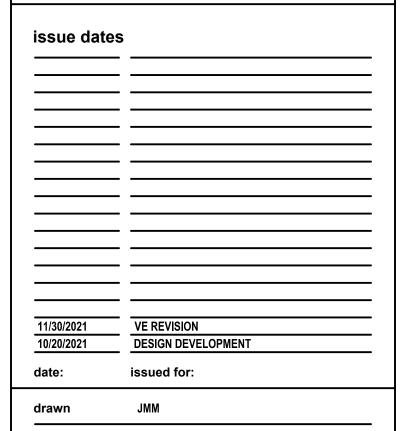


project no.

20102

drawing no.

NORTH 1/4 COR

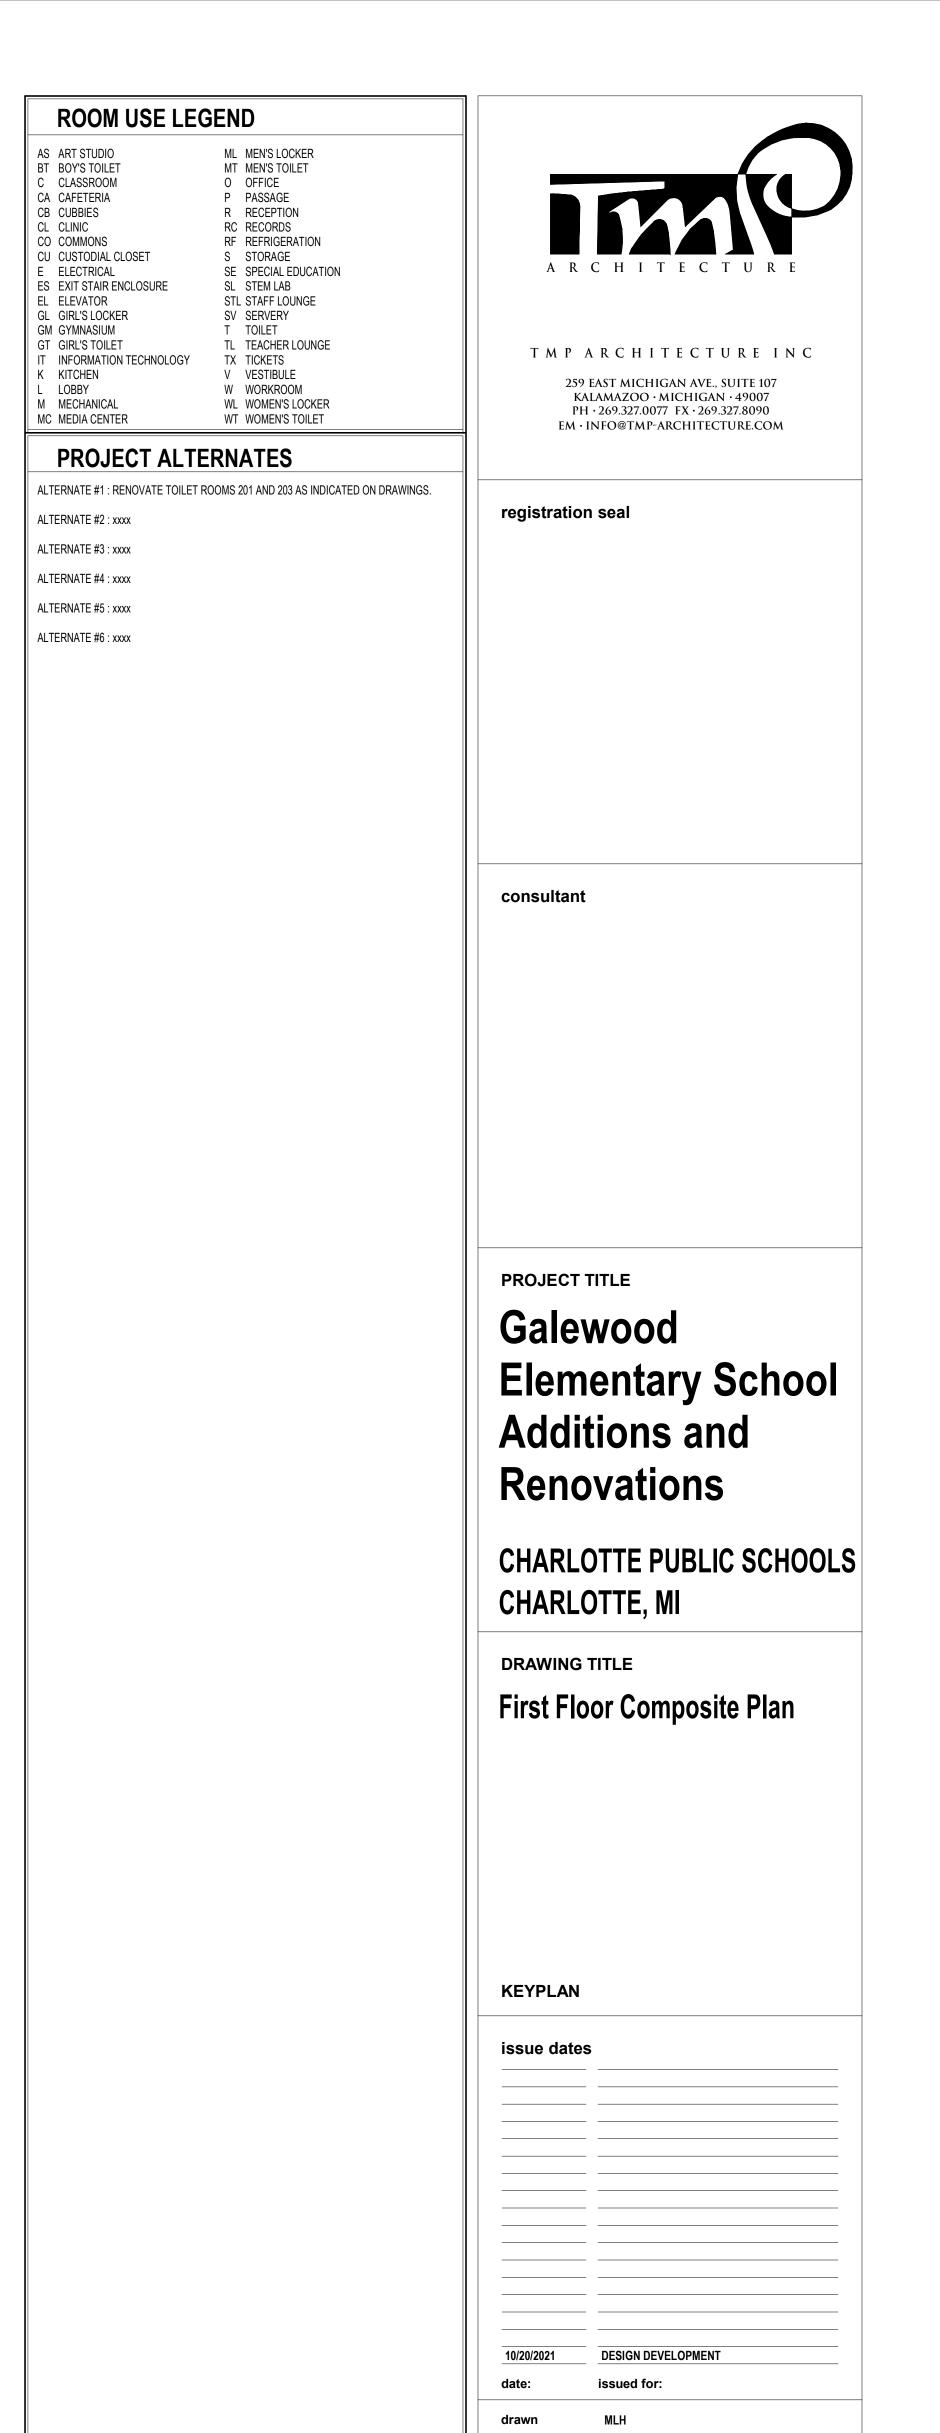

project no.

20102

drawing no.

AC.1

LOCKER LEGEND

TYPE SINGLE-TIER STANDARD LOCKERS (12" X 15" X 60" HIGH)
VENTILATED, ON CONCRETE BASE ()

SINGLE-TIER ADA ACCESSIBLE LOCKERS (12" X 15" X 60" HIGH) VENTILATED, ON CONCRETE BASE () (REFER TO PLANS FOR ADA LOCATIONS)

TYPE DOUBLE-TIER STANDARD LOCKERS (12" X 15" X 60" HIGH)
L-2 VENTILATED. ON CONCRETE BASE () VENTILATED, ON CONCRETE BASE ()

TYPE SINGLE-TIER STANDARD LOCKERS (15" X 15" X 72" HIGH) VENTILATED, ON METAL 'Z' BASE

WALL / PARTITION KEY

METAL STUD PARTITION

CMU PARTITION

(Aa) WALL / PARTITION LEGEND

1B 3 5/8" METAL STUDS @ 16" OC (MAX) W/ 5/8" GYP BOARD ONE SIDE TO 6" ABOVE CEILING 1F 3 5/8" METAL STUDS @ 16" OC (MAX) W/ 5/8" GYP BOARD ONE SIDE TO STRUCTURE ABOVE

2C 3 5/8" METAL STUDS @ 16" OC (MAX) W/ 5/8" GYP BOARD BOTH SIDES TO STRUCTURE ABOVE 2D 6" METAL STUDS @ 16" OC (MAX) W/ 5/8" GYP BOARD BOTH SIDES TO STRUCTURE ABOVE 2E 3 5/8" METAL STUDS @ 16" OC (MAX) W/ 5/8" GYP BOARD BOTH SIDES TO STRUCTURE ABOVE, 1

HOUR RATED UL DESIGN NO. U465 4A 4" CMU TO ONE FULL COURSE ABOVE CEILING

4E 4" CMU TO STRUCTURE ABOVE

4F 6" CMU TO STRUCTURE ABOVE

4G 8" CMU TO STRUCTURE ABOVE 4G 8" CMU TO STRUCTURE ABOVE

4H 12" CMU TO STRUCTURE ABOVE 4M 8" CMU TO STRUCTURE ABOVE - SMOKE PARTITION FOR EGRESS CORRIDORS

PARTIAL HEIGHT CMU WALLS WILL BE NOTED AS SUCH ON THE FLOOR PLANS.

EQUIPMENT SUPPORTS WITH APPROPRIATE EQUIPMENT MANUFACTURER.

SAME. ACCESS PANELS ARE SPECIFIED ARCHITECTURALLY BUT ARE REQUIRED TO BE PROVIDED BY EACH TRADE. ALL LOCATIONS MUST BE COORDINATED AND APPROVED BY

LOCATIONS, AND FLOOR ELEVATIONS IN THE FIELD AND NOTIFY THE ARCHITECTS

MADE PRIOR TO FABRICATION AND/OR INSTALLATION OF AFFECTED WORK. NOTIFY ARCHITECTS REPRESENTATIVE IF DISCREPANCIES ARISE BEFORE PROCEEDING WITH THE

WALLS, CEILINGS, BULKHEADS, FASCIAE AND SOFFITS IN COMPLIANCE WITH SPECIFICATIONS, AND WITH GENERAL REQUIREMENTS OF ASTM C840. PRIOR TO COMMENCEMENT OF FRAMING INSTALLATION SUBMIT COORDINATION DRAWINGS

INDICATING PROPOSED LOCATIONS OF ALL CONTROL JOINTS, AS SPECIFIED.

LINTELS REQUIRED FOR THESE OPENINGS PER SPECIFICATIONS.

7. PROVIDE CONTROL JOINTS WHERE INTERIOR CMU (ON SLAB) ABUTS EXTERIOR/INTERIOR

MECHANICAL AND ELECTRICAL WORK WITH THE APPROPRIATE TRADE. PROVIDE ALL OPENINGS SHOWN OR REQUIRED FOR THE COMPLETION OF THE WORK. PROVIDE ALL

BECAUSE OF THE DRAWING SCALE OF THE LIFE SAFETY PLANS, COORDINATE THE REQUIRED FIRE RESISTANCE RATINGS WITH THOSE SHOWN ON THE REFLECTED CEILING

1. REFER TO STRUCTURAL DRAWINGS FOR ALL WIND FRAME LOCATIONS AT INTERIOR AND

BARS, TOWEL DISPENSERS, PENCIL SHARPENERS, WALL STOPS, ACCORDIAN PARTITION

CLASSROOM ELEVATIONS W/ ARCH EQUIPMENT AND NOTIFY ARCHITECT'S REPRESENTATIVE

JAMBS, ETC. REFER ALSO TO A9._ SERIES AND A6._ SERIES DRAWINGS.

REPRESENTATIVE OF ANY DISCREPANCIES BEFORE START OF WORK.

TERMINATION AT EXISTING SMOKE-RESISTING WALLS.

THE ARCHITECT'S FIELD REPRESENTATIVE.

MASONRY (ON FOUNDATIONS OR FOOTINGS).

EXTERIOR WALLS.

JOINTS IN EXTERIOR WALLS.

5C 8" CMU TO STRUCTURE ABOVE, 1HR FIRE PARTITION FOR STORAGE AND UTILITY ROOMS 7C 8" CMU TO STRUCTURE ABOVE, 3 HOUR RATED, UL DESIGN NO. U904



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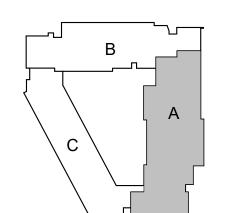
PROJECT TITLE

Galewood **Elementary School** Additions and Renovations

CHARLOTTE PUBLIC SCHOOLS CHARLOTTE, MI

DRAWING TITLE

First Floor Plan - Zone 'A'




KEYPLAN

issue date	es	
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10/20/2021	DESIGN DEVELOPMENT	
date:	issued for:	
drawn	MLH	

20102

drawing no. **A1.1A**

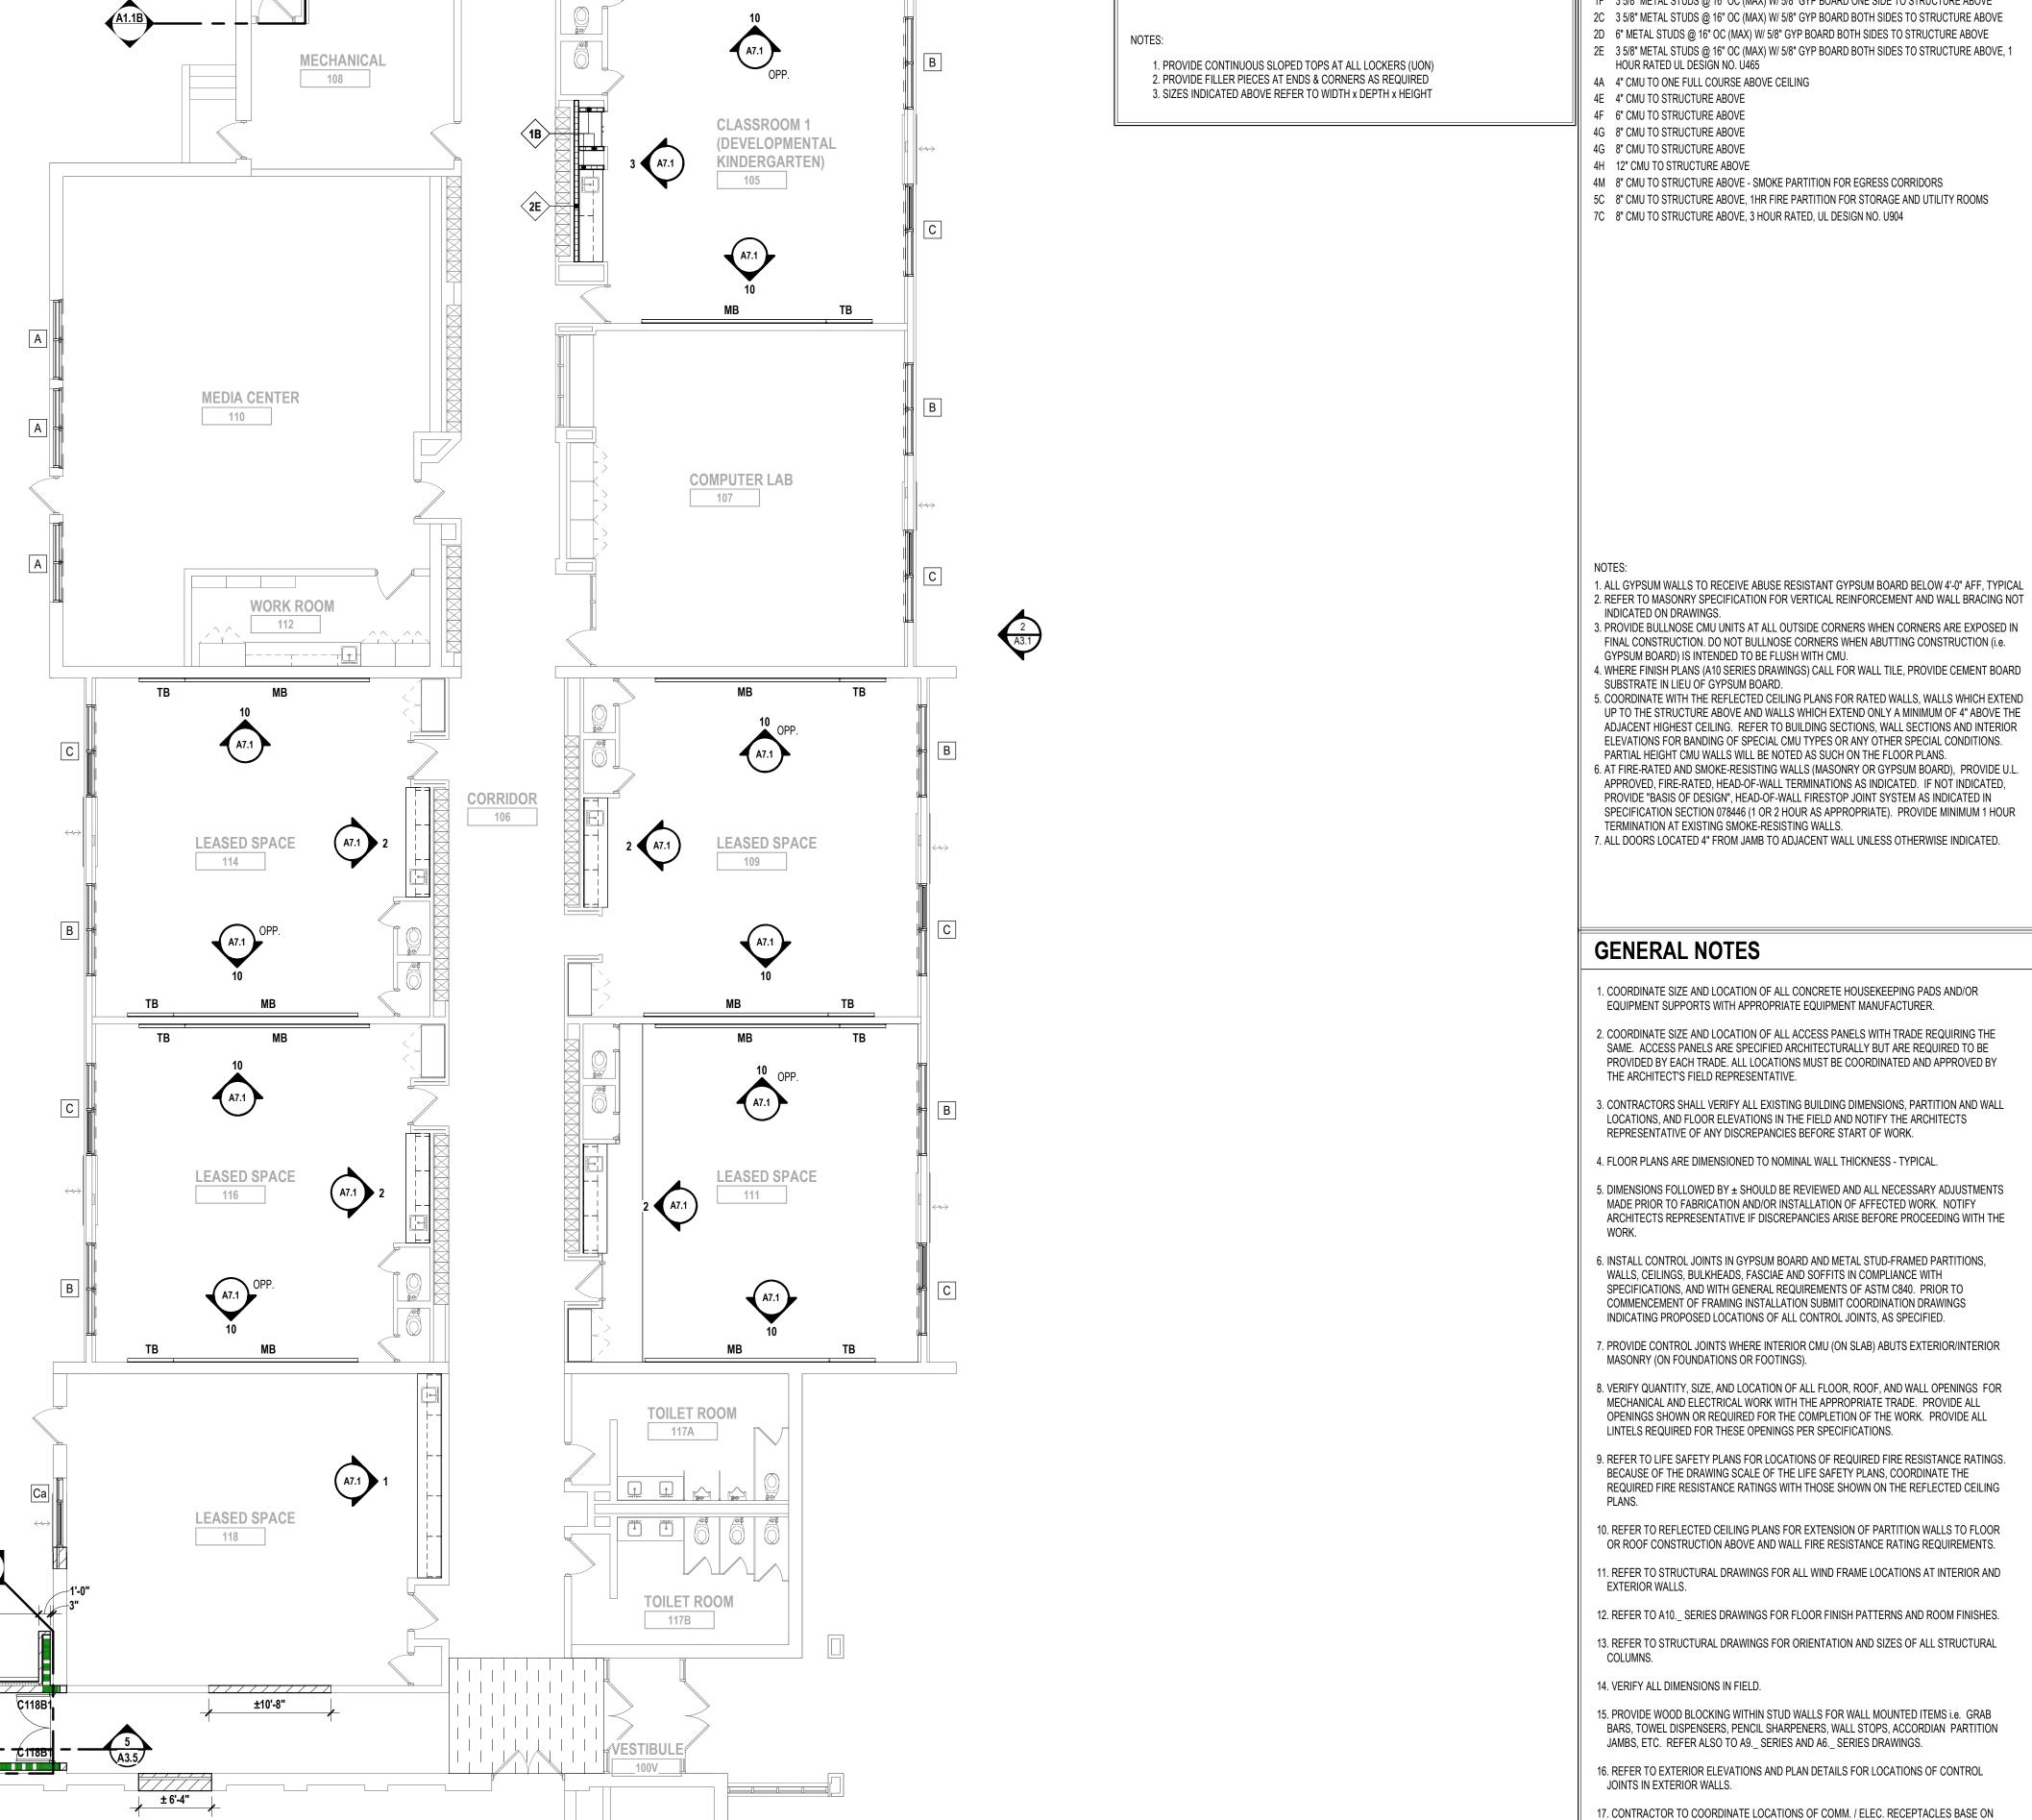

LOCKER LEGEND TYPE SINGLE-TIER STANDARD LOCKERS (12" X 15" X 60" HIGH) VENTILATED, ON CONCRETE BASE () SINGLE-TIER ADA ACCESSIBLE LOCKERS (12" X 15" X 60" HIGH) VENTILATED, ON CONCRETE BASE () (REFER TO PLANS FOR ADA LOCATIONS) TYPE DOUBLE-TIER STANDARD LOCKERS (12" X 15" X 60" HIGH) L-2 VENTILATED ON CONCRETE BASE () VENTILATED, ON CONCRETE BASE () TYPE SINGLE-TIER STANDARD LOCKERS (15" X 15" X 72" HIGH) VENTILATED, ON METAL 'Z' BASE

1. PROVIDE CONTINUOUS SLOPED TOPS AT ALL LOCKERS (UON) 2. PROVIDE FILLER PIECES AT ENDS & CORNERS AS REQUIRED 3. SIZES INDICATED ABOVE REFER TO WIDTH x DEPTH x HEIGHT

WALL / PARTITION KEY

METAL STUD PARTITION

CMU PARTITION

(Aa) WALL / PARTITION LEGEND

- 1B 3 5/8" METAL STUDS @ 16" OC (MAX) W/ 5/8" GYP BOARD ONE SIDE TO 6" ABOVE CEILING 1F 3 5/8" METAL STUDS @ 16" OC (MAX) W/ 5/8" GYP BOARD ONE SIDE TO STRUCTURE ABOVE
- 2C 3 5/8" METAL STUDS @ 16" OC (MAX) W/ 5/8" GYP BOARD BOTH SIDES TO STRUCTURE ABOVE 2D 6" METAL STUDS @ 16" OC (MAX) W/ 5/8" GYP BOARD BOTH SIDES TO STRUCTURE ABOVE 2E 3 5/8" METAL STUDS @ 16" OC (MAX) W/ 5/8" GYP BOARD BOTH SIDES TO STRUCTURE ABOVE, 1
- HOUR RATED UL DESIGN NO. U465 4A 4" CMU TO ONE FULL COURSE ABOVE CEILING
- 4E 4" CMU TO STRUCTURE ABOVE
- 4F 6" CMU TO STRUCTURE ABOVE 4G 8" CMU TO STRUCTURE ABOVE
- 4G 8" CMU TO STRUCTURE ABOVE
- 4H 12" CMU TO STRUCTURE ABOVE 4M 8" CMU TO STRUCTURE ABOVE - SMOKE PARTITION FOR EGRESS CORRIDORS
- 5C 8" CMU TO STRUCTURE ABOVE, 1HR FIRE PARTITION FOR STORAGE AND UTILITY ROOMS 7C 8" CMU TO STRUCTURE ABOVE, 3 HOUR RATED, UL DESIGN NO. U904

registration seal

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259 EAST MICHIGAN AVE., SUITE 107

KALAMAZOO · MICHIGAN · 49007

PH · 269.327.0077 FX · 269.327.8090

EM · INFO@TMP-ARCHITECTURE.COM

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Galewood **Additions and**

MASONRY (ON FOUNDATIONS OR FOOTINGS). 8. VERIFY QUANTITY, SIZE, AND LOCATION OF ALL FLOOR, ROOF, AND WALL OPENINGS FOR

9. REFER TO LIFE SAFETY PLANS FOR LOCATIONS OF REQUIRED FIRE RESISTANCE RATINGS. BECAUSE OF THE DRAWING SCALE OF THE LIFE SAFETY PLANS, COORDINATE THE REQUIRED FIRE RESISTANCE RATINGS WITH THOSE SHOWN ON THE REFLECTED CEILING

10. REFER TO REFLECTED CEILING PLANS FOR EXTENSION OF PARTITION WALLS TO FLOOR OR ROOF CONSTRUCTION ABOVE AND WALL FIRE RESISTANCE RATING REQUIREMENTS. 1. REFER TO STRUCTURAL DRAWINGS FOR ALL WIND FRAME LOCATIONS AT INTERIOR AND

12. REFER TO A10._ SERIES DRAWINGS FOR FLOOR FINISH PATTERNS AND ROOM FINISHES. 13. REFER TO STRUCTURAL DRAWINGS FOR ORIENTATION AND SIZES OF ALL STRUCTURAL

14. VERIFY ALL DIMENSIONS IN FIELD.

EXTERIOR WALLS.

15. PROVIDE WOOD BLOCKING WITHIN STUD WALLS FOR WALL MOUNTED ITEMS i.e. GRAB BARS, TOWEL DISPENSERS, PENCIL SHARPENERS, WALL STOPS, ACCORDIAN PARTITION JAMBS, ETC. REFER ALSO TO A9._ SERIES AND A6._ SERIES DRAWINGS.

16. REFER TO EXTERIOR ELEVATIONS AND PLAN DETAILS FOR LOCATIONS OF CONTROL

JOINTS IN EXTERIOR WALLS. 17. CONTRACTOR TO COORDINATE LOCATIONS OF COMM. / ELEC. RECEPTACLES BASE ON CLASSROOM ELEVATIONS W/ ARCH EQUIPMENT AND NOTIFY ARCHITECT'S REPRESENTATIVE


PROJECT TITLE

Elementary School Renovations

CHARLOTTE PUBLIC SCHOOLS CHARLOTTE, MI

DRAWING TITLE

First Floor Plan - Zone 'B'

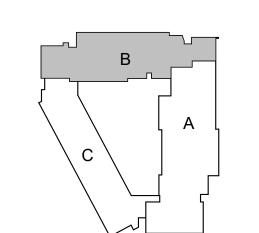


KEYPLAN

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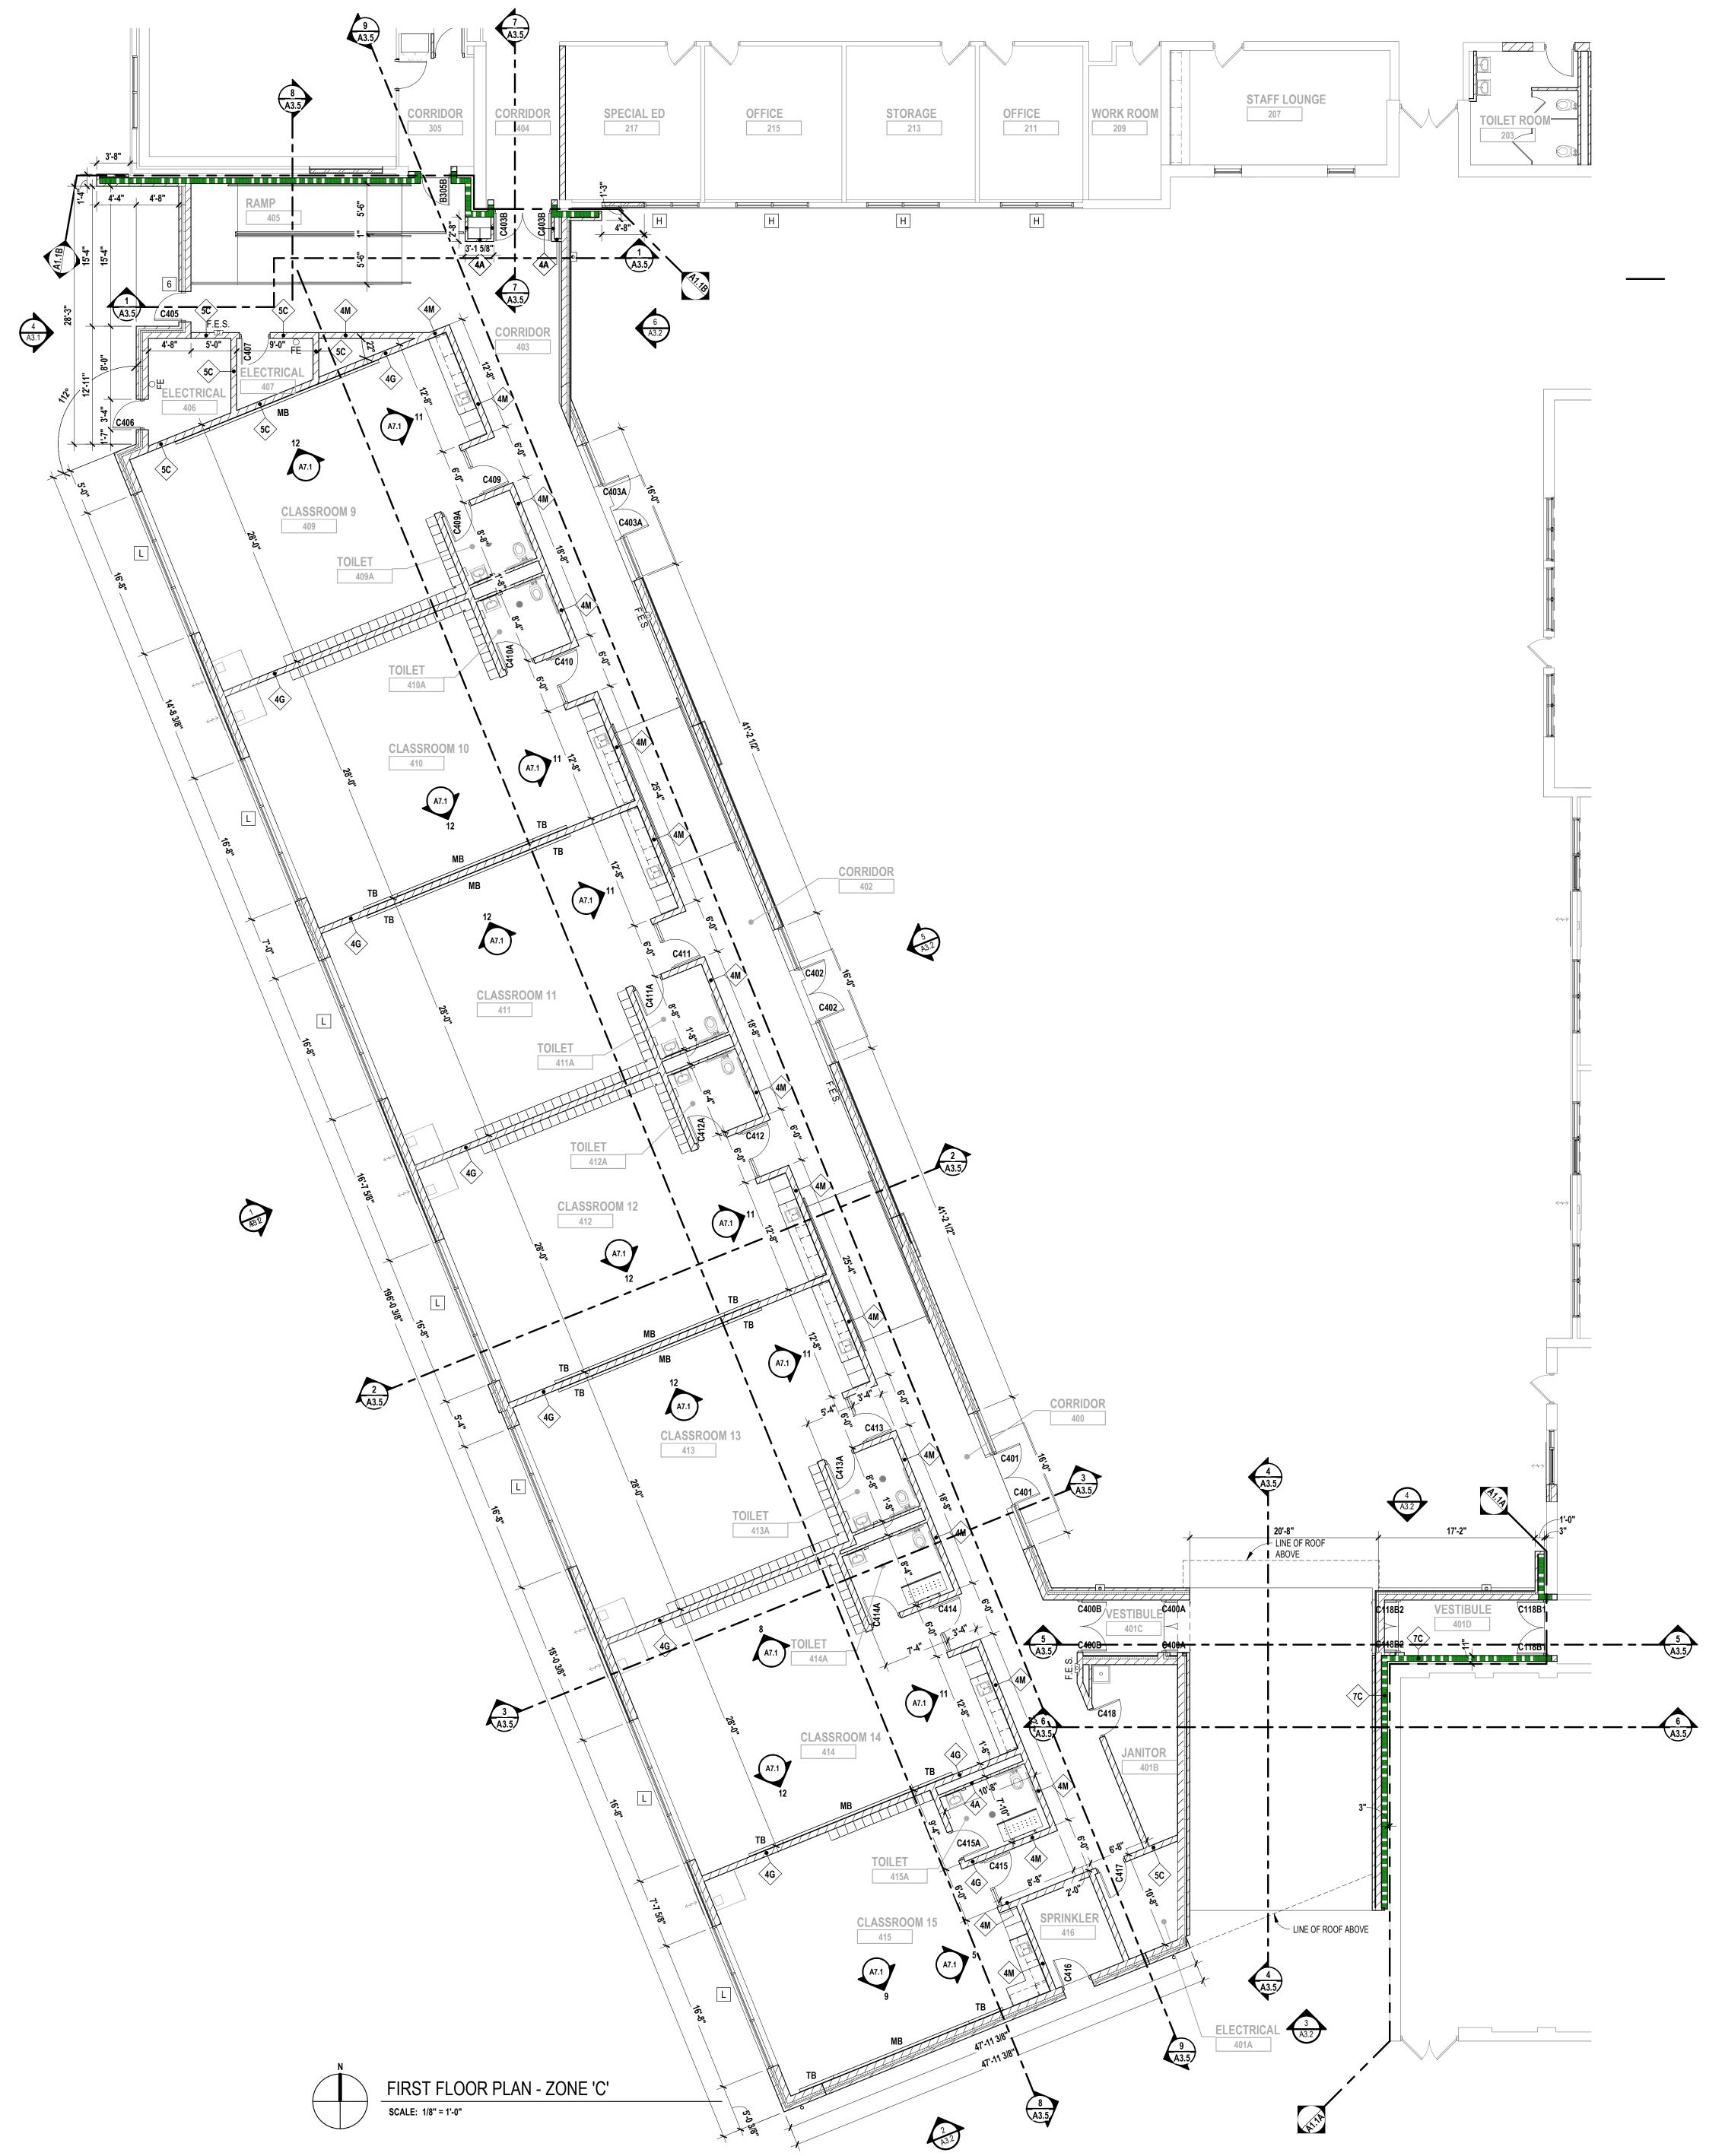
20102

A1.1B

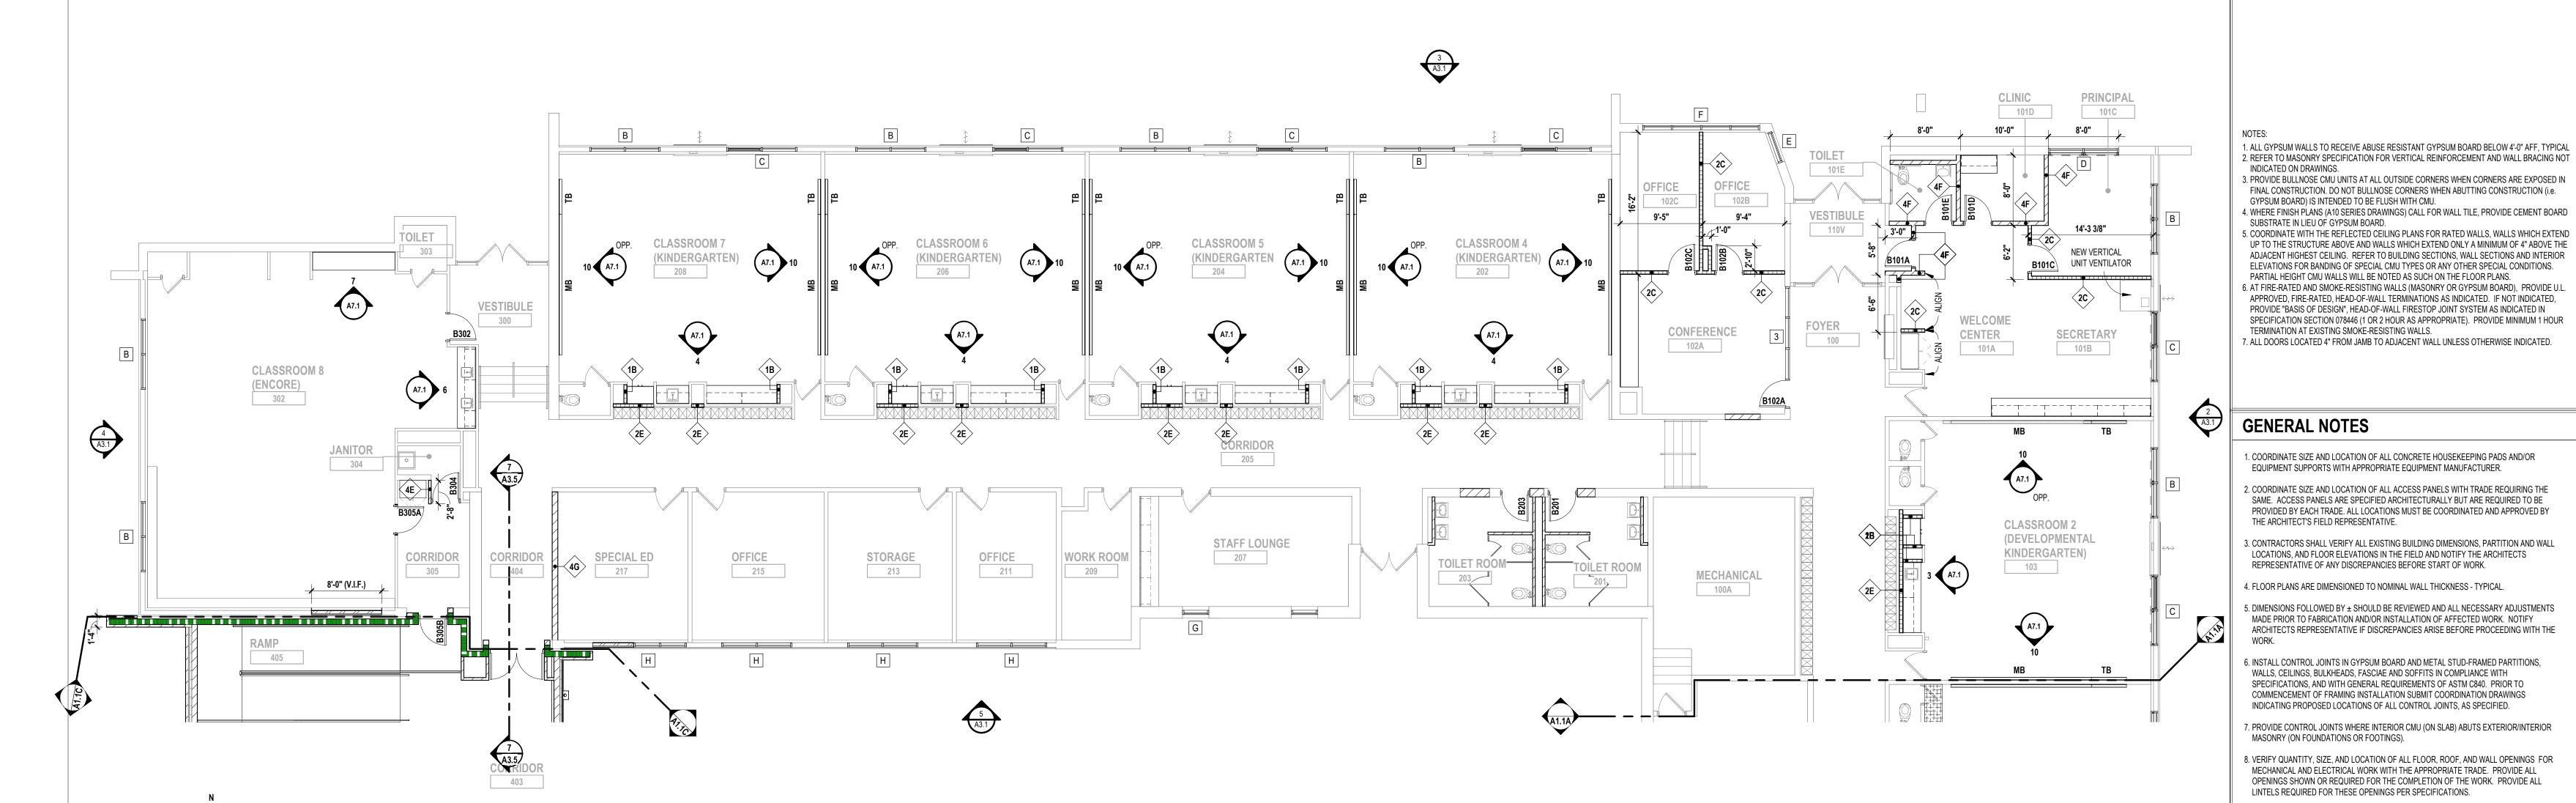

FIRST FLOOR PLAN - ZONE 'B'

SCALE: 1/8" = 1'-0"



LOCKER LEGEND

SINGLE-TIER STANDARD LOCKERS (12" X 15" X 60" HIGH) VENTILATED, ON CONCRETE BASE (

SINGLE-TIER ADA ACCESSIBLE LOCKERS (12" X 15" X 60" HIGH) VENTILATED, ON CONCRETE BASE () (REFER TO PLANS FOR ADA LOCATIONS)

VENTILATED, ON CONCRETE BASE ()

TYPE SINGLE-TIER STANDARD LOCKERS (15" X 15" X 72" HIGH) VENTILATED, ON METAL 'Z' BASE

1. PROVIDE CONTINUOUS SLOPED TOPS AT ALL LOCKERS (UON) 2. PROVIDE FILLER PIECES AT ENDS & CORNERS AS REQUIRED 3. SIZES INDICATED ABOVE REFER TO WIDTH x DEPTH x HEIGHT

WALL / PARTITION KEY

METAL STUD PARTITION

CMU PARTITION



- 1B 3 5/8" METAL STUDS @ 16" OC (MAX) W/ 5/8" GYP BOARD ONE SIDE TO 6" ABOVE CEILING 1F 3 5/8" METAL STUDS @ 16" OC (MAX) W/ 5/8" GYP BOARD ONE SIDE TO STRUCTURE ABOVE
- 2C 3 5/8" METAL STUDS @ 16" OC (MAX) W/ 5/8" GYP BOARD BOTH SIDES TO STRUCTURE ABOVE 2D 6" METAL STUDS @ 16" OC (MAX) W/ 5/8" GYP BOARD BOTH SIDES TO STRUCTURE ABOVE 2E 3 5/8" METAL STUDS @ 16" OC (MAX) W/ 5/8" GYP BOARD BOTH SIDES TO STRUCTURE ABOVE, 1
- HOUR RATED UL DESIGN NO. U465 4A 4" CMU TO ONE FULL COURSE ABOVE CEILING
- 4E 4" CMU TO STRUCTURE ABOVE
- 4F 6" CMU TO STRUCTURE ABOVE 4G 8" CMU TO STRUCTURE ABOVE
- 4G 8" CMU TO STRUCTURE ABOVE
- 4H 12" CMU TO STRUCTURE ABOVE
- 4M 8" CMU TO STRUCTURE ABOVE SMOKE PARTITION FOR EGRESS CORRIDORS 5C 8" CMU TO STRUCTURE ABOVE, 1HR FIRE PARTITION FOR STORAGE AND UTILITY ROOMS

7C 8" CMU TO STRUCTURE ABOVE, 3 HOUR RATED, UL DESIGN NO. U904

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2. REFER TO MASONRY SPECIFICATION FOR VERTICAL REINFORCEMENT AND WALL BRACING NOT

3. PROVIDE BULLNOSE CMU UNITS AT ALL OUTSIDE CORNERS WHEN CORNERS ARE EXPOSED IN FINAL CONSTRUCTION. DO NOT BULLNOSE CORNERS WHEN ABUTTING CONSTRUCTION (i.e. GYPSUM BOARD) IS INTENDED TO BE FLUSH WITH CMU. 4. WHERE FINISH PLANS (A10 SERIES DRAWINGS) CALL FOR WALL TILE, PROVIDE CEMENT BOARD

1. ALL GYPSUM WALLS TO RECEIVE ABUSE RESISTANT GYPSUM BOARD BELOW 4'-0" AFF, TYPICAL

SUBSTRATE IN LIEU OF GYPSUM BOARD. 5. COORDINATE WITH THE REFLECTED CEILING PLANS FOR RATED WALLS, WALLS WHICH EXTEND UP TO THE STRUCTURE ABOVE AND WALLS WHICH EXTEND ONLY A MINIMUM OF 4" ABOVE THE ADJACENT HIGHEST CEILING. REFER TO BUILDING SECTIONS, WALL SECTIONS AND INTERIOR ELEVATIONS FOR BANDING OF SPECIAL CMU TYPES OR ANY OTHER SPECIAL CONDITIONS. PARTIAL HEIGHT CMU WALLS WILL BE NOTED AS SUCH ON THE FLOOR PLANS. 6. AT FIRE-RATED AND SMOKE-RESISTING WALLS (MASONRY OR GYPSUM BOARD), PROVIDE U.L. APPROVED, FIRE-RATED, HEAD-OF-WALL TERMINATIONS AS INDICATED. IF NOT INDICATED, PROVIDE "BASIS OF DESIGN", HEAD-OF-WALL FIRESTOP JOINT SYSTEM AS INDICATED IN SPECIFICATION SECTION 078446 (1 OR 2 HOUR AS APPROPRIATE). PROVIDE MINIMUM 1 HOUR

TERMINATION AT EXISTING SMOKE-RESISTING WALLS. 7. ALL DOORS LOCATED 4" FROM JAMB TO ADJACENT WALL UNLESS OTHERWISE INDICATED.

GENERAL NOTES

INDICATED ON DRAWINGS.

- 1. COORDINATE SIZE AND LOCATION OF ALL CONCRETE HOUSEKEEPING PADS AND/OR EQUIPMENT SUPPORTS WITH APPROPRIATE EQUIPMENT MANUFACTURER.
- 2. COORDINATE SIZE AND LOCATION OF ALL ACCESS PANELS WITH TRADE REQUIRING THE SAME. ACCESS PANELS ARE SPECIFIED ARCHITECTURALLY BUT ARE REQUIRED TO BE PROVIDED BY EACH TRADE. ALL LOCATIONS MUST BE COORDINATED AND APPROVED BY THE ARCHITECT'S FIELD REPRESENTATIVE.
- 3. CONTRACTORS SHALL VERIFY ALL EXISTING BUILDING DIMENSIONS, PARTITION AND WALL LOCATIONS, AND FLOOR ELEVATIONS IN THE FIELD AND NOTIFY THE ARCHITECTS REPRESENTATIVE OF ANY DISCREPANCIES BEFORE START OF WORK.
- 4. FLOOR PLANS ARE DIMENSIONED TO NOMINAL WALL THICKNESS TYPICAL.
- 5. DIMENSIONS FOLLOWED BY ± SHOULD BE REVIEWED AND ALL NECESSARY ADJUSTMENTS MADE PRIOR TO FABRICATION AND/OR INSTALLATION OF AFFECTED WORK. NOTIFY ARCHITECTS REPRESENTATIVE IF DISCREPANCIES ARISE BEFORE PROCEEDING WITH THE
- 6. INSTALL CONTROL JOINTS IN GYPSUM BOARD AND METAL STUD-FRAMED PARTITIONS, WALLS, CEILINGS, BULKHEADS, FASCIAE AND SOFFITS IN COMPLIANCE WITH SPECIFICATIONS, AND WITH GENERAL REQUIREMENTS OF ASTM C840. PRIOR TO COMMENCEMENT OF FRAMING INSTALLATION SUBMIT COORDINATION DRAWINGS
- INDICATING PROPOSED LOCATIONS OF ALL CONTROL JOINTS, AS SPECIFIED. 7. PROVIDE CONTROL JOINTS WHERE INTERIOR CMU (ON SLAB) ABUTS EXTERIOR/INTERIOR MASONRY (ON FOUNDATIONS OR FOOTINGS).
- 8. VERIFY QUANTITY, SIZE, AND LOCATION OF ALL FLOOR, ROOF, AND WALL OPENINGS FOR MECHANICAL AND ELECTRICAL WORK WITH THE APPROPRIATE TRADE. PROVIDE ALL OPENINGS SHOWN OR REQUIRED FOR THE COMPLETION OF THE WORK. PROVIDE ALL LINTELS REQUIRED FOR THESE OPENINGS PER SPECIFICATIONS.
- 9. REFER TO LIFE SAFETY PLANS FOR LOCATIONS OF REQUIRED FIRE RESISTANCE RATINGS. BECAUSE OF THE DRAWING SCALE OF THE LIFE SAFETY PLANS, COORDINATE THE REQUIRED FIRE RESISTANCE RATINGS WITH THOSE SHOWN ON THE REFLECTED CEILING
- 10. REFER TO REFLECTED CEILING PLANS FOR EXTENSION OF PARTITION WALLS TO FLOOR OR ROOF CONSTRUCTION ABOVE AND WALL FIRE RESISTANCE RATING REQUIREMENTS.
- 1. REFER TO STRUCTURAL DRAWINGS FOR ALL WIND FRAME LOCATIONS AT INTERIOR AND EXTERIOR WALLS. 12. REFER TO A10._ SERIES DRAWINGS FOR FLOOR FINISH PATTERNS AND ROOM FINISHES.
- 14. VERIFY ALL DIMENSIONS IN FIELD.
- 15. PROVIDE WOOD BLOCKING WITHIN STUD WALLS FOR WALL MOUNTED ITEMS i.e. GRAB BARS, TOWEL DISPENSERS, PENCIL SHARPENERS, WALL STOPS, ACCORDIAN PARTITION JAMBS, ETC. REFER ALSO TO A9._ SERIES AND A6._ SERIES DRAWINGS.

13. REFER TO STRUCTURAL DRAWINGS FOR ORIENTATION AND SIZES OF ALL STRUCTURAL

- 16. REFER TO EXTERIOR ELEVATIONS AND PLAN DETAILS FOR LOCATIONS OF CONTROL JOINTS IN EXTERIOR WALLS.
- 17. CONTRACTOR TO COORDINATE LOCATIONS OF COMM. / ELEC. RECEPTACLES BASE ON CLASSROOM ELEVATIONS W/ ARCH EQUIPMENT AND NOTIFY ARCHITECT'S REPRESENTATIVE


PROJECT TITLE

Galewood Elementary School Additions and Renovations

CHARLOTTE PUBLIC SCHOOLS CHARLOTTE, MI

DRAWING TITLE

First Floor Plan - Zone 'C'

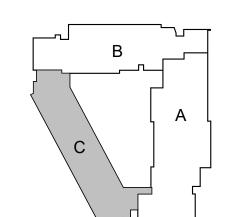


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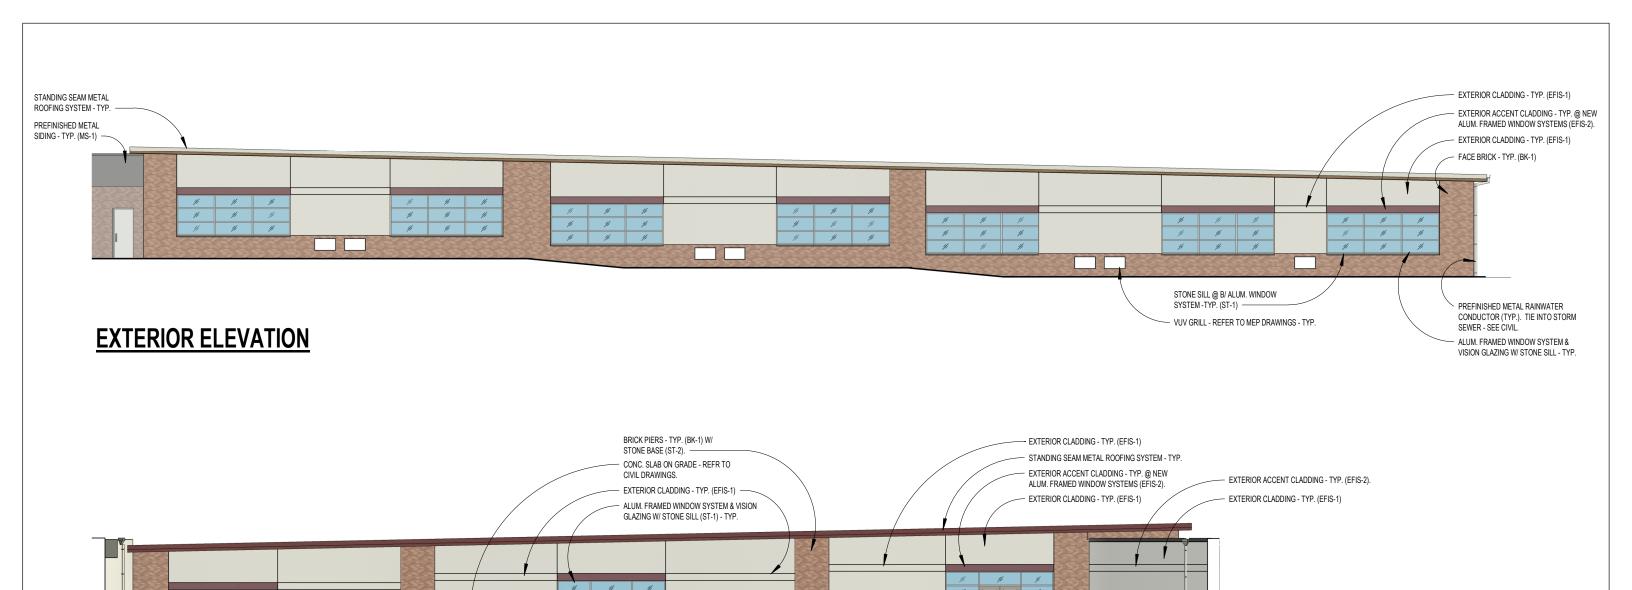
20102

drawing no. A1.1C



CHARLOTTE - GALEWOOD ELEMENTARY SCHOOL ADDITION

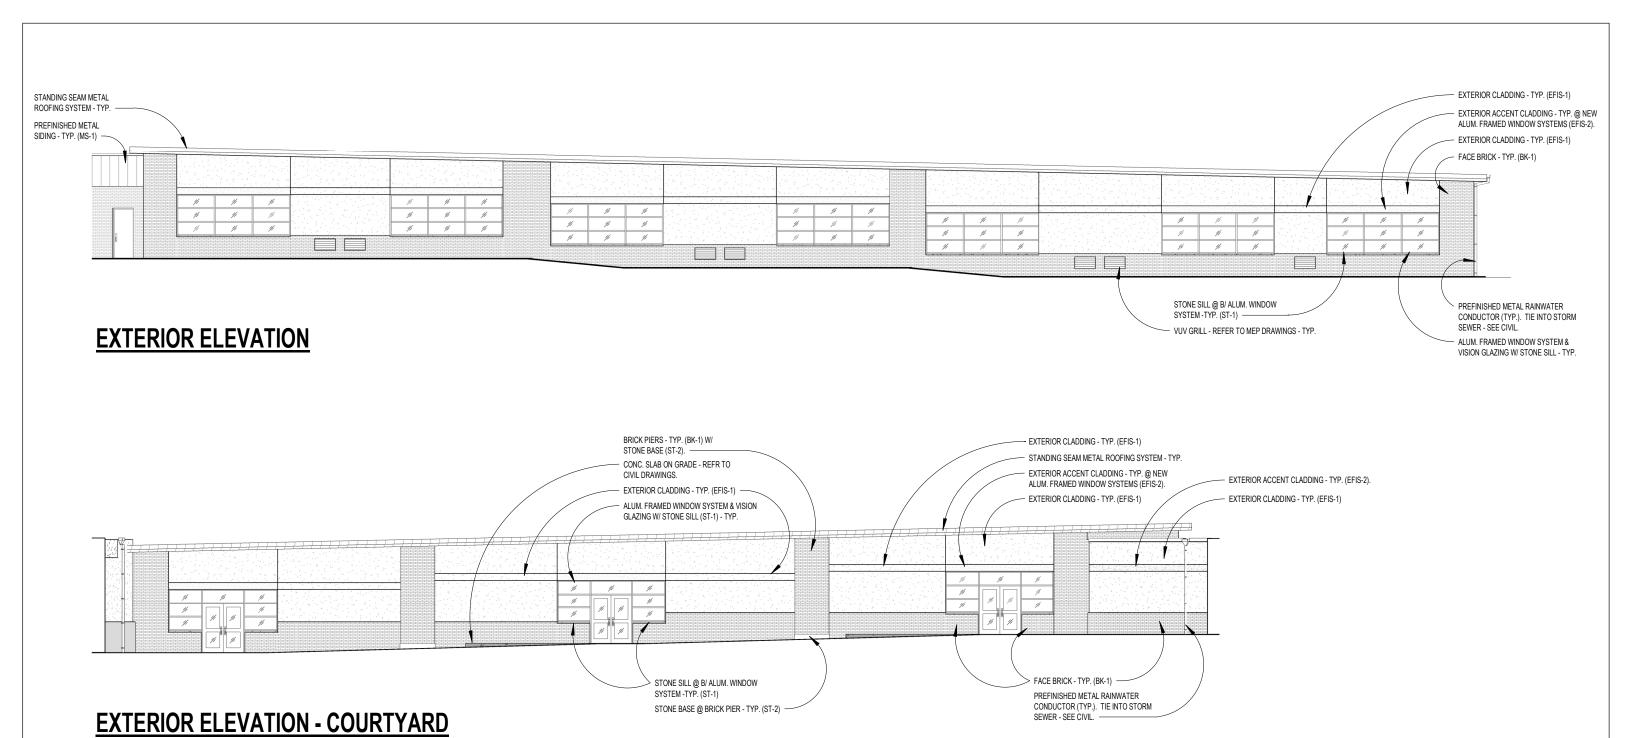



STONE SILL @ B/ ALUM. WINDOW SYSTEM -TYP. (ST-1)

STONE BASE @ BRICK PIER - TYP. (ST-2)

FACE BRICK - TYP. (BK-1)

STORM SEWER - SEE CIVIL.

PREFINISHED METAL RAINWATER CONDUCTOR (TYP.). TIE INTO

EXTERIOR ELEVATION - COURTYARD

CHARLOTTE - GALEWOOD ELEMENTARY SCHOOL ADDITION





CHARLOTTE - GALEWOOD ELEMENTARY SCHOOL ADDITION



Washington Elementary

SITE BM#100 ARROW ON HYDRANT LOCATED +/_19' WEST OF CENTERLINE OF HIGH STREET AND +/-30' NORTH OF THE BUSS LOOP EXIT DRIVEWAY FROM WASHINGTON SCHOOL.

SITE BM#101 CHISELED "+" ON SOUTH SIDE OF CONC LP BASE LOCATED SOUTH OF NORTH ASPH PARKING LOT +/-.37' WEST OF GLASS ENCLOSURES &+/-3' SOUTH OF CONC WALK.

DATUM: GPS-DERIVED NADV '88

SITE IMPROVEMENT LEGEND

___ CONSTRUCTION LIMITS FIRE PROTECTION WATER SERVICE ELECTRICAL SERVICE LINE × × FENCE

MILL AND RESURFACE. STANDARD DUTY PAVEMENT. CONCRETE SIDEWALK

LAWN/LANDSCAPE AREA STORM WATER DETENTION RECONFIGURATION


SITE IMPROVEMENT KEY

- 1 RELOCATED BUS SHELTER
- 2 LIGHT POLE FIXTURE REPLACEMENT LOCATION. REFER TO ELECTRICAL SHEET FOR MORE INFORMATION.
- 3 NEW LIGHT POLE FIXTURE LOCATION. CONSTRUCT CONCRETE BASE PER MANUFACTURER'S RECOMMENDATION. REFER TO ELECTRICAL SHEET FOR MORE INFORMATION.
- (4) RESURFACED HMA SURFACE SHALL BE RE-STRIPED TO MATCH EXISTING
- 5 CONCRETE ELECTRICAL UTILITY PAD WITH CHAIN LINK FENCE. SEE ELECTRICAL SHEET FOR MORE INFORMATION.
- 6 MDOT TYPE-M DRIVEWAY OPENING.—

SITE IMPROVEMENT NOTES

- 1. ALL AREAS SHOWN NOT BUILT, PAVED OR OTHERWISE COVERED BY CONSTRUCTION SHALL BE HYDROMULCH SEEDED, REFER TO SPECS FOR DETAILS.
- 2. ALL AREAS DISTURBED BY CONSTRUCTION WHICH ARE OUTSIDE THE CONSTRUCTION LIMITS SHALL BE RESTORED TO A CONDITION EQUAL TO, OR BETTER THAN EXISTING CONDITIONS.
- 3. THE SITE CONTRACTOR SHALL COORDINATE WORK WITH ALL ADJACENT CONSTRUCTION BY OTHERS.
- 4. REFER TO SHEET C-XXX FOR SITE GRADING DESIGN.

5. REFER TO SHEET C-XXX FOR SITE UTILITY DESIGN.

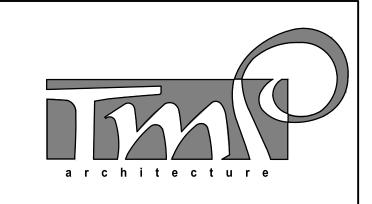

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consultant



PROJECT TITLE

Washington Elementary School **Addition and** Renovations

CHARLOTTE PUBLIC SCHOOLS CHARLOTTE, MI

DRAWING TITLE

SITE IMPROVEMENTS AND GEOMETRICS PLAN

KEYPLAN

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10/20/2021	DESIGN DEVELOPMENT	
late:	issued for:	
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project no.

20104

drawing no. C-103



PROJECT ALTERNATES ALTERNATE #1: PHENOLIC LOCKERS IN LIEU OF METAL LOCKERS.

ROOM USE LEGEND

ML MEN'S LOCKER MT MEN'S TOILET

O OFFICE

P PASSAGE

R RECEPTION

RC RECORDS

S STORAGE

SL STEM LAB

SV SERVERY

TOILET TL TEACHER LOUNGE

W WORKROOM

WL WOMEN'S LOCKER

WT WOMEN'S TOILET

TX TICKETS V VESTIBULE

RF REFRIGERATION

STP STAFF PLANNING

SE SPECIAL EDUCATION

ALTERNATE #2 : XXXX ALTERNATE #3 : XXXX

AS ART STUDIO BT BOY'S TOILET C CLASSROOM

CA CAFETERIA

CL CLINIC

CO COMMONS

EL ELEVATOR

GL GIRL'S LOCKER

GT GIRL'S TOILET

M MECHANICAL

MC MEDIA CENTER

GM GYMNASIUM

K KITCHEN

LOBBY

CC COLLABORATION CENTER

CU CUSTODIAL CLOSET

E ELECTRICAL ES EXIT STAIR ENCLOSURE

IT INFORMATION TECHNOLOGY


ALTERNATE #4 : XXXX

ALTERNATE #5 : XXXX ALTERNATE #6 : XXXX

project no.

20104

drawing no. AC.1

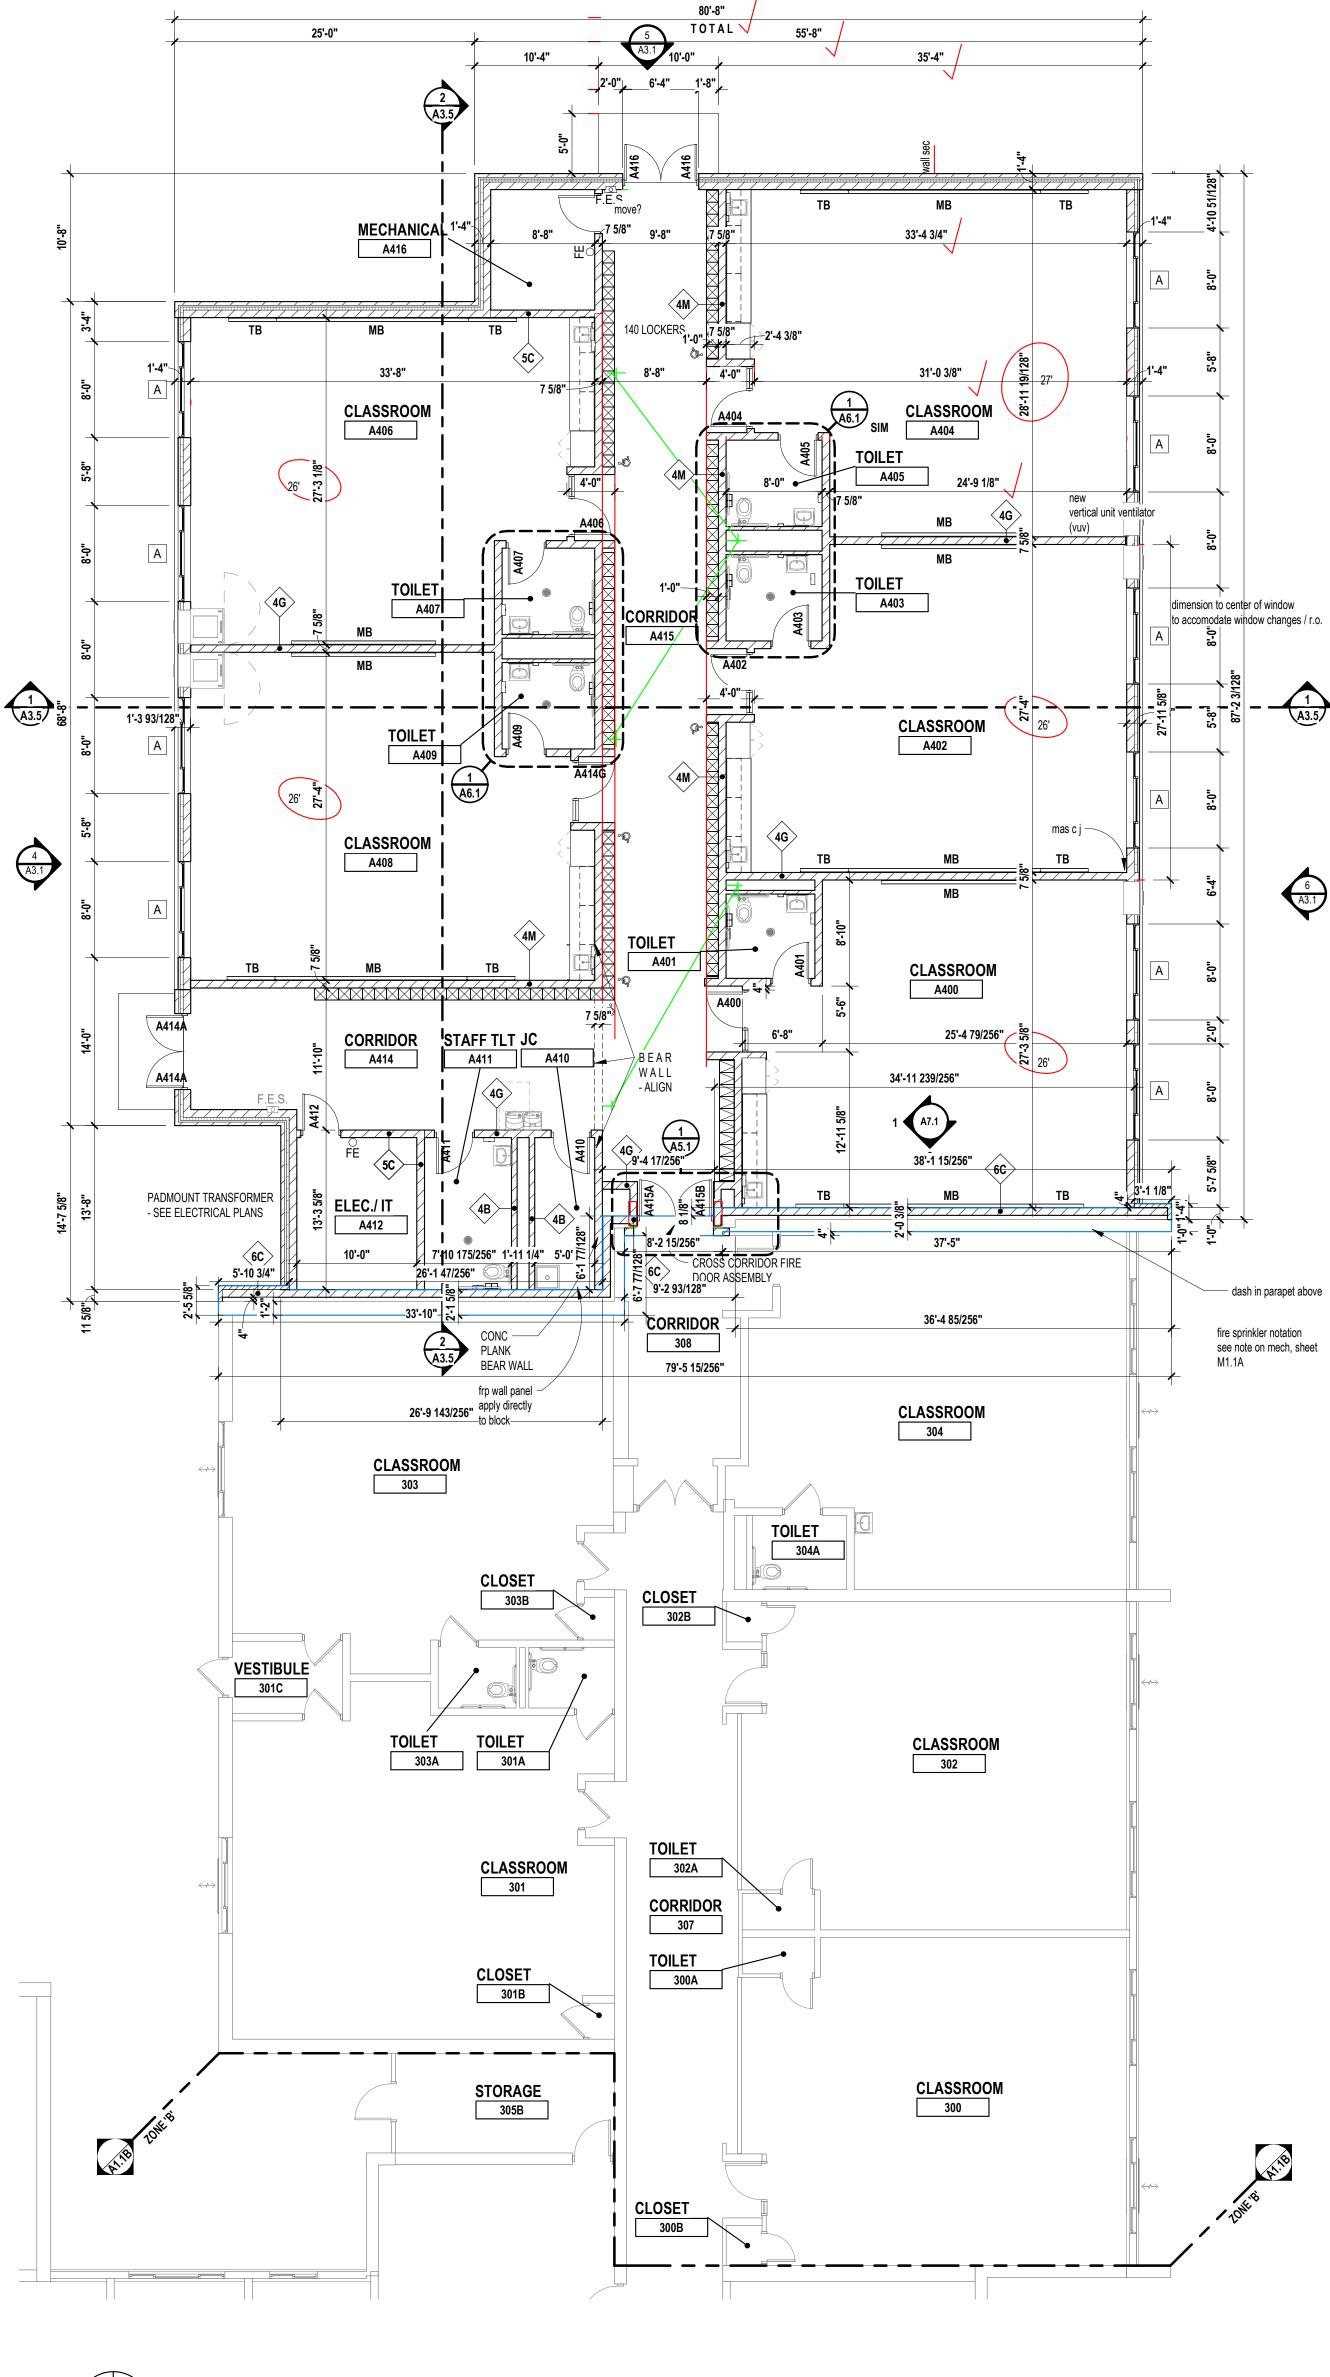

FIRST FLOOR PLAN - ZONE 'A' SCALE: 1/8" = 1'-0"

LOCKER LEGEND

SINGLE-TIER STANDARD LOCKERS (12" X 12" X 60" HIGH) VENTILATED, ON CONCRETE BASE (12 / A8.1)

SINGLE-TIER ADA ACCESSIBLE LOCKERS (12" X 12" X 60" HIGH) VENTILATED, ON CONCRETE BASE (12 / A8.1) (REFER TO PLANS FOR ADA LOCATIONS)

TYPE DOUBLE-TIER STANDARD LOCKERS (12" X 15" X 60" HIGH)
L-2 VENTILATED, ON CONCRETE BASE (12 / A8.1)

NOTES:

1. PROVIDE CONTINUOUS SLOPED TOPS AT ALL LOCKERS (UON) 2. PROVIDE FILLER PIECES AT ENDS & CORNERS AS REQUIRED 3. SIZES INDICATED ABOVE REFER TO WIDTH x DEPTH x HEIGHT

WALL / PARTITION KEY

METAL STUD PARTITION

CMU PARTITION

(AB) WALL / PARTITION LEGEND

- 2A 3 5/8" METAL STUDS @ 16" OC (MAX) W/ 5/8" GYP BOARD BOTH SIDES TO 6" ABOVE CEILING 2B 6" METAL STUDS @ 16" OC (MAX) W/ 5/8" GYP BOARD BOTH SIDES TO 6" ABOVE CEILING
- 4A 4" CMU TO ONE FULL COURSE ABOVE CEILING
- 4B 6" CMU TO ONE FULL COURSE ABOVE CEILING
- 4C 8" CMU TO ONE FULL COURSE ABOVE CEILING
- 4D 12" CMU TO ONE FULL COURSE ABOVE CEILING 4E 4" CMU TO STRUCTURE ABOVE
- 4F 6" CMU TO STRUCTURE ABOVE 4G 8" CMU TO STRUCTURE ABOVE
- 4H 12" CMU TO STRUCTURE ABOVE
- 4M 8" CMU TO STRUCTURE ABOVE SMOKE PARTITION FOR EGRESS CORRIDORS 5C 8" CMU TO STRUCTURE ABOVE, 1HR FIRE PARTITION FOR STORAGE AND UTILITY ROOMS
- 6C 8" CMU TO STRUCTURE ABOVE, 2 HOUR RATED, UL DESIGN NO. U905
- 6D FIRE WALL: 12" CMU TO STRUCTURE ABOVE, 2 HOUR RATED, UL DESIGN NO. U905 7C 8" CMU TO STRUCTURE ABOVE, 3 HOUR RATED, UL DESIGN NO. U904



TMP ARCHITECTURE INC 259 EAST MICHIGAN AVE., SUITE 107 KALAMAZOO · MICHIGAN · 49007 PH · 269.327.0077 FX · 269.327.8090 EM · INFO@TMP-ARCHITECTURE.COM

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1. ALL GYPSUM WALLS TO RECEIVE ABUSE RESISTANT GYPSUM BOARD BELOW 4'-0" AFF, TYPICAL

2. REFER TO MASONRY SPECIFICATION FOR VERTICAL REINFORCEMENT AND WALL BRACING NOT INDICATED ON DRAWINGS. 3. PROVIDE BULLNOSE CMU UNITS AT ALL OUTSIDE CORNERS WHEN CORNERS ARE EXPOSED IN FINAL CONSTRUCTION. DO NOT BULLNOSE CORNERS WHEN ABUTTING CONSTRUCTION (i.e. GYPSUM BOARD) IS INTENDED TO BE FLUSH WITH CMU.

4. WHERE FINISH PLANS (A10 SERIES DRAWINGS) CALL FOR WALL TILE, PROVIDE CEMENT BOARD SUBSTRATE IN LIEU OF GYPSUM BOARD. 5. COORDINATE WITH THE REFLECTED CEILING PLANS FOR RATED WALLS, WALLS WHICH EXTEND UP TO THE STRUCTURE ABOVE AND WALLS WHICH EXTEND ONLY A MINIMUM OF 4" ABOVE THE ADJACENT HIGHEST CEILING. REFER TO BUILDING SECTIONS, WALL SECTIONS AND INTERIOR ELEVATIONS FOR BANDING OF SPECIAL CMU TYPES OR ANY OTHER SPECIAL CONDITIONS.

6. AT FIRE-RATED AND SMOKE-RESISTING WALLS (MASONRY OR GYPSUM BOARD), PROVIDE U.L. APPROVED, FIRE-RATED, HEAD-OF-WALL TERMINATIONS AS INDICATED. IF NOT INDICATED, PROVIDE "BASIS OF DESIGN", HEAD-OF-WALL FIRESTOP JOINT SYSTEM AS INDICATED IN SPECIFICATION SECTION 078446 (1 OR 2 HOUR AS APPROPRIATE). PROVIDE MINIMUM 1 HOUR TERMINATION AT EXISTING SMOKE-RESISTING WALLS.

7. ALL DOORS LOCATED 4" FROM JAMB TO ADJACENT WALL UNLESS OTHERWISE INDICATED.

PARTIAL HEIGHT CMU WALLS WILL BE NOTED AS SUCH ON THE FLOOR PLANS.

GENERAL NOTES

1. COORDINATE SIZE AND LOCATION OF ALL CONCRETE HOUSEKEEPING PADS AND/OR EQUIPMENT SUPPORTS WITH APPROPRIATE EQUIPMENT MANUFACTURER.

2. COORDINATE SIZE AND LOCATION OF ALL ACCESS PANELS WITH TRADE REQUIRING THE SAME. ACCESS PANELS ARE SPECIFIED ARCHITECTURALLY BUT ARE REQUIRED TO BE PROVIDED BY EACH TRADE. ALL LOCATIONS MUST BE COORDINATED AND APPROVED BY THE ARCHITECT'S FIELD REPRESENTATIVE.

3. CONTRACTORS SHALL VERIFY ALL EXISTING BUILDING DIMENSIONS, PARTITION AND WALL LOCATIONS, AND FLOOR ELEVATIONS IN THE FIELD AND NOTIFY THE ARCHITECTS REPRESENTATIVE OF ANY DISCREPANCIES BEFORE START OF WORK.

4. FLOOR PLANS ARE DIMENSIONED TO NOMINAL WALL THICKNESS - TYPICAL.

5. DIMENSIONS FOLLOWED BY ± SHOULD BE REVIEWED AND ALL NECESSARY ADJUSTMENTS MADE PRIOR TO FABRICATION AND/OR INSTALLATION OF AFFECTED WORK. NOTIFY ARCHITECTS REPRESENTATIVE IF DISCREPANCIES ARISE BEFORE PROCEEDING WITH THE

6. INSTALL CONTROL JOINTS IN GYPSUM BOARD AND METAL STUD-FRAMED PARTITIONS, WALLS, CEILINGS, BULKHEADS, FASCIAE AND SOFFITS IN COMPLIANCE WITH SPECIFICATIONS, AND WITH GENERAL REQUIREMENTS OF ASTM C840. PRIOR TO COMMENCEMENT OF FRAMING INSTALLATION SUBMIT COORDINATION DRAWINGS INDICATING PROPOSED LOCATIONS OF ALL CONTROL JOINTS, AS SPECIFIED.

7. PROVIDE CONTROL JOINTS WHERE INTERIOR CMU (ON SLAB) ABUTS EXTERIOR/INTERIOR MASONRY (ON FOUNDATIONS OR FOOTINGS).

8. VERIFY QUANTITY, SIZE, AND LOCATION OF ALL FLOOR, ROOF, AND WALL OPENINGS FOR MECHANICAL AND ELECTRICAL WORK WITH THE APPROPRIATE TRADE. PROVIDE ALL OPENINGS SHOWN OR REQUIRED FOR THE COMPLETION OF THE WORK. PROVIDE ALL LINTELS REQUIRED FOR THESE OPENINGS PER SPECIFICATIONS.

9. REFER TO LIFE SAFETY PLANS FOR LOCATIONS OF REQUIRED FIRE RESISTANCE RATINGS. BECAUSE OF THE DRAWING SCALE OF THE LIFE SAFETY PLANS, COORDINATE THE REQUIRED FIRE RESISTANCE RATINGS WITH THOSE SHOWN ON THE REFLECTED CEILING

10. REFER TO REFLECTED CEILING PLANS FOR EXTENSION OF PARTITION WALLS TO FLOOR OR ROOF CONSTRUCTION ABOVE AND WALL FIRE RESISTANCE RATING REQUIREMENTS. 1. REFER TO STRUCTURAL DRAWINGS FOR ALL WIND FRAME LOCATIONS AT INTERIOR AND

12. REFER TO A10._ SERIES DRAWINGS FOR FLOOR FINISH PATTERNS AND ROOM FINISHES. 13. REFER TO STRUCTURAL DRAWINGS FOR ORIENTATION AND SIZES OF ALL STRUCTURAL

14. VERIFY ALL DIMENSIONS IN FIELD.

EXTERIOR WALLS.

15. PROVIDE WOOD BLOCKING WITHIN STUD WALLS FOR WALL MOUNTED ITEMS i.e. GRAB BARS, TOWEL DISPENSERS, PENCIL SHARPENERS, WALL STOPS, ACCORDIAN PARTITION JAMBS, ETC. REFER ALSO TO A9._ SERIES AND A6._ SERIES DRAWINGS.

16. REFER TO EXTERIOR ELEVATIONS AND PLAN DETAILS FOR LOCATIONS OF CONTROL JOINTS IN EXTERIOR WALLS.

17. CONTRACTOR TO COORDINATE LOCATIONS OF COMM. / ELEC. RECEPTACLES BASE ON CLASSROOM ELEVATIONS W/ ARCH EQUIPMENT AND NOTIFY ARCHITECT'S REPRESENTATIVE


PROJECT TITLE

Washington **Elementary School Addition and** Renovations

CHARLOTTE PUBLIC SCHOOLS CHARLOTTE, MI

DRAWING TITLE

First Floor Plan - Zone 'A'

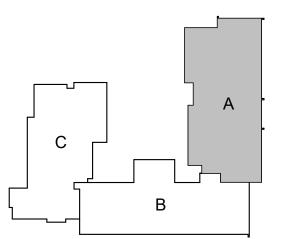

KEYPLAN

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project no.

20104

drawing no. **A1.1A**

L-1 SINGLE-TIER ADA ACCESSIBLE LOCKERS (12" X 12" X 60" HIGH) VENTILATED, ON CONCRETE BASE (12 / A8.1) (REFER TO PLANS FOR ADA LOCATIONS)

TYPE DOUBLE-TIER STANDARD LOCKERS (12" X 15" X 60" HIGH) VENTILATED, ON CONCRETE BASE (12 / A8.1)

SINGLE-TIER STANDARD LOCKERS (12" X 12" X 60" HIGH)
VENTILATED, ON CONCRETE BASE (12 / A8.1)

1. PROVIDE CONTINUOUS SLOPED TOPS AT ALL LOCKERS (UON) 2. PROVIDE FILLER PIECES AT ENDS & CORNERS AS REQUIRED 3. SIZES INDICATED ABOVE REFER TO WIDTH x DEPTH x HEIGHT WALL / PARTITION KEY

METAL STUD PARTITION

CMU PARTITION

(Aa) WALL / PARTITION LEGEND

2A 3 5/8" METAL STUDS @ 16" OC (MAX) W/ 5/8" GYP BOARD BOTH SIDES TO 6" ABOVE CEILING 2B 6" METAL STUDS @ 16" OC (MAX) W/ 5/8" GYP BOARD BOTH SIDES TO 6" ABOVE CEILING

4A 4" CMU TO ONE FULL COURSE ABOVE CEILING 4B 6" CMU TO ONE FULL COURSE ABOVE CEILING

4C 8" CMU TO ONE FULL COURSE ABOVE CEILING 4D 12" CMU TO ONE FULL COURSE ABOVE CEILING

4E 4" CMU TO STRUCTURE ABOVE 4F 6" CMU TO STRUCTURE ABOVE

4G 8" CMU TO STRUCTURE ABOVE 4H 12" CMU TO STRUCTURE ABOVE

4M 8" CMU TO STRUCTURE ABOVE - SMOKE PARTITION FOR EGRESS CORRIDORS 5C 8" CMU TO STRUCTURE ABOVE, 1HR FIRE PARTITION FOR STORAGE AND UTILITY ROOMS

6C 8" CMU TO STRUCTURE ABOVE, 2 HOUR RATED, UL DESIGN NO. U905 6D FIRE WALL: 12" CMU TO STRUCTURE ABOVE, 2 HOUR RATED, UL DESIGN NO. U905

7C 8" CMU TO STRUCTURE ABOVE, 3 HOUR RATED, UL DESIGN NO. U904

TMP ARCHITECTURE INC

259 EAST MICHIGAN AVE., SUITE 107

KALAMAZOO · MICHIGAN · 49007

PH · 269.327.0077 FX · 269.327.8090

EM · INFO@TMP-ARCHITECTURE.COM

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2. REFER TO MASONRY SPECIFICATION FOR VERTICAL REINFORCEMENT AND WALL BRACING NOT INDICATED ON DRAWINGS. 3. PROVIDE BULLNOSE CMU UNITS AT ALL OUTSIDE CORNERS WHEN CORNERS ARE EXPOSED IN FINAL CONSTRUCTION. DO NOT BULLNOSE CORNERS WHEN ABUTTING CONSTRUCTION (i.e. GYPSUM BOARD) IS INTENDED TO BE FLUSH WITH CMU. 4. WHERE FINISH PLANS (A10 SERIES DRAWINGS) CALL FOR WALL TILE, PROVIDE CEMENT BOARD

1. ALL GYPSUM WALLS TO RECEIVE ABUSE RESISTANT GYPSUM BOARD BELOW 4'-0" AFF, TYPICAL

SUBSTRATE IN LIEU OF GYPSUM BOARD. 5. COORDINATE WITH THE REFLECTED CEILING PLANS FOR RATED WALLS, WALLS WHICH EXTEND UP TO THE STRUCTURE ABOVE AND WALLS WHICH EXTEND ONLY A MINIMUM OF 4" ABOVE THE ADJACENT HIGHEST CEILING. REFER TO BUILDING SECTIONS, WALL SECTIONS AND INTERIOR ELEVATIONS FOR BANDING OF SPECIAL CMU TYPES OR ANY OTHER SPECIAL CONDITIONS. PARTIAL HEIGHT CMU WALLS WILL BE NOTED AS SUCH ON THE FLOOR PLANS. 6. AT FIRE-RATED AND SMOKE-RESISTING WALLS (MASONRY OR GYPSUM BOARD), PROVIDE U.L. APPROVED, FIRE-RATED, HEAD-OF-WALL TERMINATIONS AS INDICATED. IF NOT INDICATED, PROVIDE "BASIS OF DESIGN", HEAD-OF-WALL FIRESTOP JOINT SYSTEM AS INDICATED IN

TERMINATION AT EXISTING SMOKE-RESISTING WALLS. 7. ALL DOORS LOCATED 4" FROM JAMB TO ADJACENT WALL UNLESS OTHERWISE INDICATED.

SPECIFICATION SECTION 078446 (1 OR 2 HOUR AS APPROPRIATE). PROVIDE MINIMUM 1 HOUR

GENERAL NOTES

1. COORDINATE SIZE AND LOCATION OF ALL CONCRETE HOUSEKEEPING PADS AND/OR EQUIPMENT SUPPORTS WITH APPROPRIATE EQUIPMENT MANUFACTURER.

2. COORDINATE SIZE AND LOCATION OF ALL ACCESS PANELS WITH TRADE REQUIRING THE SAME. ACCESS PANELS ARE SPECIFIED ARCHITECTURALLY BUT ARE REQUIRED TO BE PROVIDED BY EACH TRADE. ALL LOCATIONS MUST BE COORDINATED AND APPROVED BY THE ARCHITECT'S FIELD REPRESENTATIVE.

3. CONTRACTORS SHALL VERIFY ALL EXISTING BUILDING DIMENSIONS, PARTITION AND WALL LOCATIONS, AND FLOOR ELEVATIONS IN THE FIELD AND NOTIFY THE ARCHITECTS REPRESENTATIVE OF ANY DISCREPANCIES BEFORE START OF WORK.

4. FLOOR PLANS ARE DIMENSIONED TO NOMINAL WALL THICKNESS - TYPICAL.

LINTELS REQUIRED FOR THESE OPENINGS PER SPECIFICATIONS.

5. DIMENSIONS FOLLOWED BY ± SHOULD BE REVIEWED AND ALL NECESSARY ADJUSTMENTS MADE PRIOR TO FABRICATION AND/OR INSTALLATION OF AFFECTED WORK. NOTIFY ARCHITECTS REPRESENTATIVE IF DISCREPANCIES ARISE BEFORE PROCEEDING WITH THE

6. INSTALL CONTROL JOINTS IN GYPSUM BOARD AND METAL STUD-FRAMED PARTITIONS, WALLS, CEILINGS, BULKHEADS, FASCIAE AND SOFFITS IN COMPLIANCE WITH SPECIFICATIONS, AND WITH GENERAL REQUIREMENTS OF ASTM C840. PRIOR TO COMMENCEMENT OF FRAMING INSTALLATION SUBMIT COORDINATION DRAWINGS INDICATING PROPOSED LOCATIONS OF ALL CONTROL JOINTS, AS SPECIFIED.

7. PROVIDE CONTROL JOINTS WHERE INTERIOR CMU (ON SLAB) ABUTS EXTERIOR/INTERIOR

MASONRY (ON FOUNDATIONS OR FOOTINGS). 8. VERIFY QUANTITY, SIZE, AND LOCATION OF ALL FLOOR, ROOF, AND WALL OPENINGS FOR MECHANICAL AND ELECTRICAL WORK WITH THE APPROPRIATE TRADE. PROVIDE ALL OPENINGS SHOWN OR REQUIRED FOR THE COMPLETION OF THE WORK. PROVIDE ALL

9. REFER TO LIFE SAFETY PLANS FOR LOCATIONS OF REQUIRED FIRE RESISTANCE RATINGS. BECAUSE OF THE DRAWING SCALE OF THE LIFE SAFETY PLANS, COORDINATE THE REQUIRED FIRE RESISTANCE RATINGS WITH THOSE SHOWN ON THE REFLECTED CEILING

10. REFER TO REFLECTED CEILING PLANS FOR EXTENSION OF PARTITION WALLS TO FLOOR OR ROOF CONSTRUCTION ABOVE AND WALL FIRE RESISTANCE RATING REQUIREMENTS.

1. REFER TO STRUCTURAL DRAWINGS FOR ALL WIND FRAME LOCATIONS AT INTERIOR AND

12. REFER TO A10._ SERIES DRAWINGS FOR FLOOR FINISH PATTERNS AND ROOM FINISHES. 13. REFER TO STRUCTURAL DRAWINGS FOR ORIENTATION AND SIZES OF ALL STRUCTURAL

14. VERIFY ALL DIMENSIONS IN FIELD.

EXTERIOR WALLS.

15. PROVIDE WOOD BLOCKING WITHIN STUD WALLS FOR WALL MOUNTED ITEMS i.e. GRAB BARS, TOWEL DISPENSERS, PENCIL SHARPENERS, WALL STOPS, ACCORDIAN PARTITION JAMBS, ETC. REFER ALSO TO A9._ SERIES AND A6._ SERIES DRAWINGS.

16. REFER TO EXTERIOR ELEVATIONS AND PLAN DETAILS FOR LOCATIONS OF CONTROL


JOINTS IN EXTERIOR WALLS. 17. CONTRACTOR TO COORDINATE LOCATIONS OF COMM. / ELEC. RECEPTACLES BASE ON CLASSROOM ELEVATIONS W/ ARCH EQUIPMENT AND NOTIFY ARCHITECT'S REPRESENTATIVE PROJECT TITLE

Washington **Elementary School Addition and** Renovations

CHARLOTTE PUBLIC SCHOOLS CHARLOTTE, MI

DRAWING TITLE

First Floor Plan - Zone 'B'

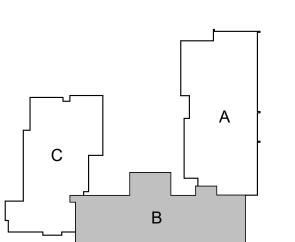



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drawing no. A1.1B





FIRST FLOOR PLAN - ZONE 'C' SCALE: 1/8" = 1'-0"

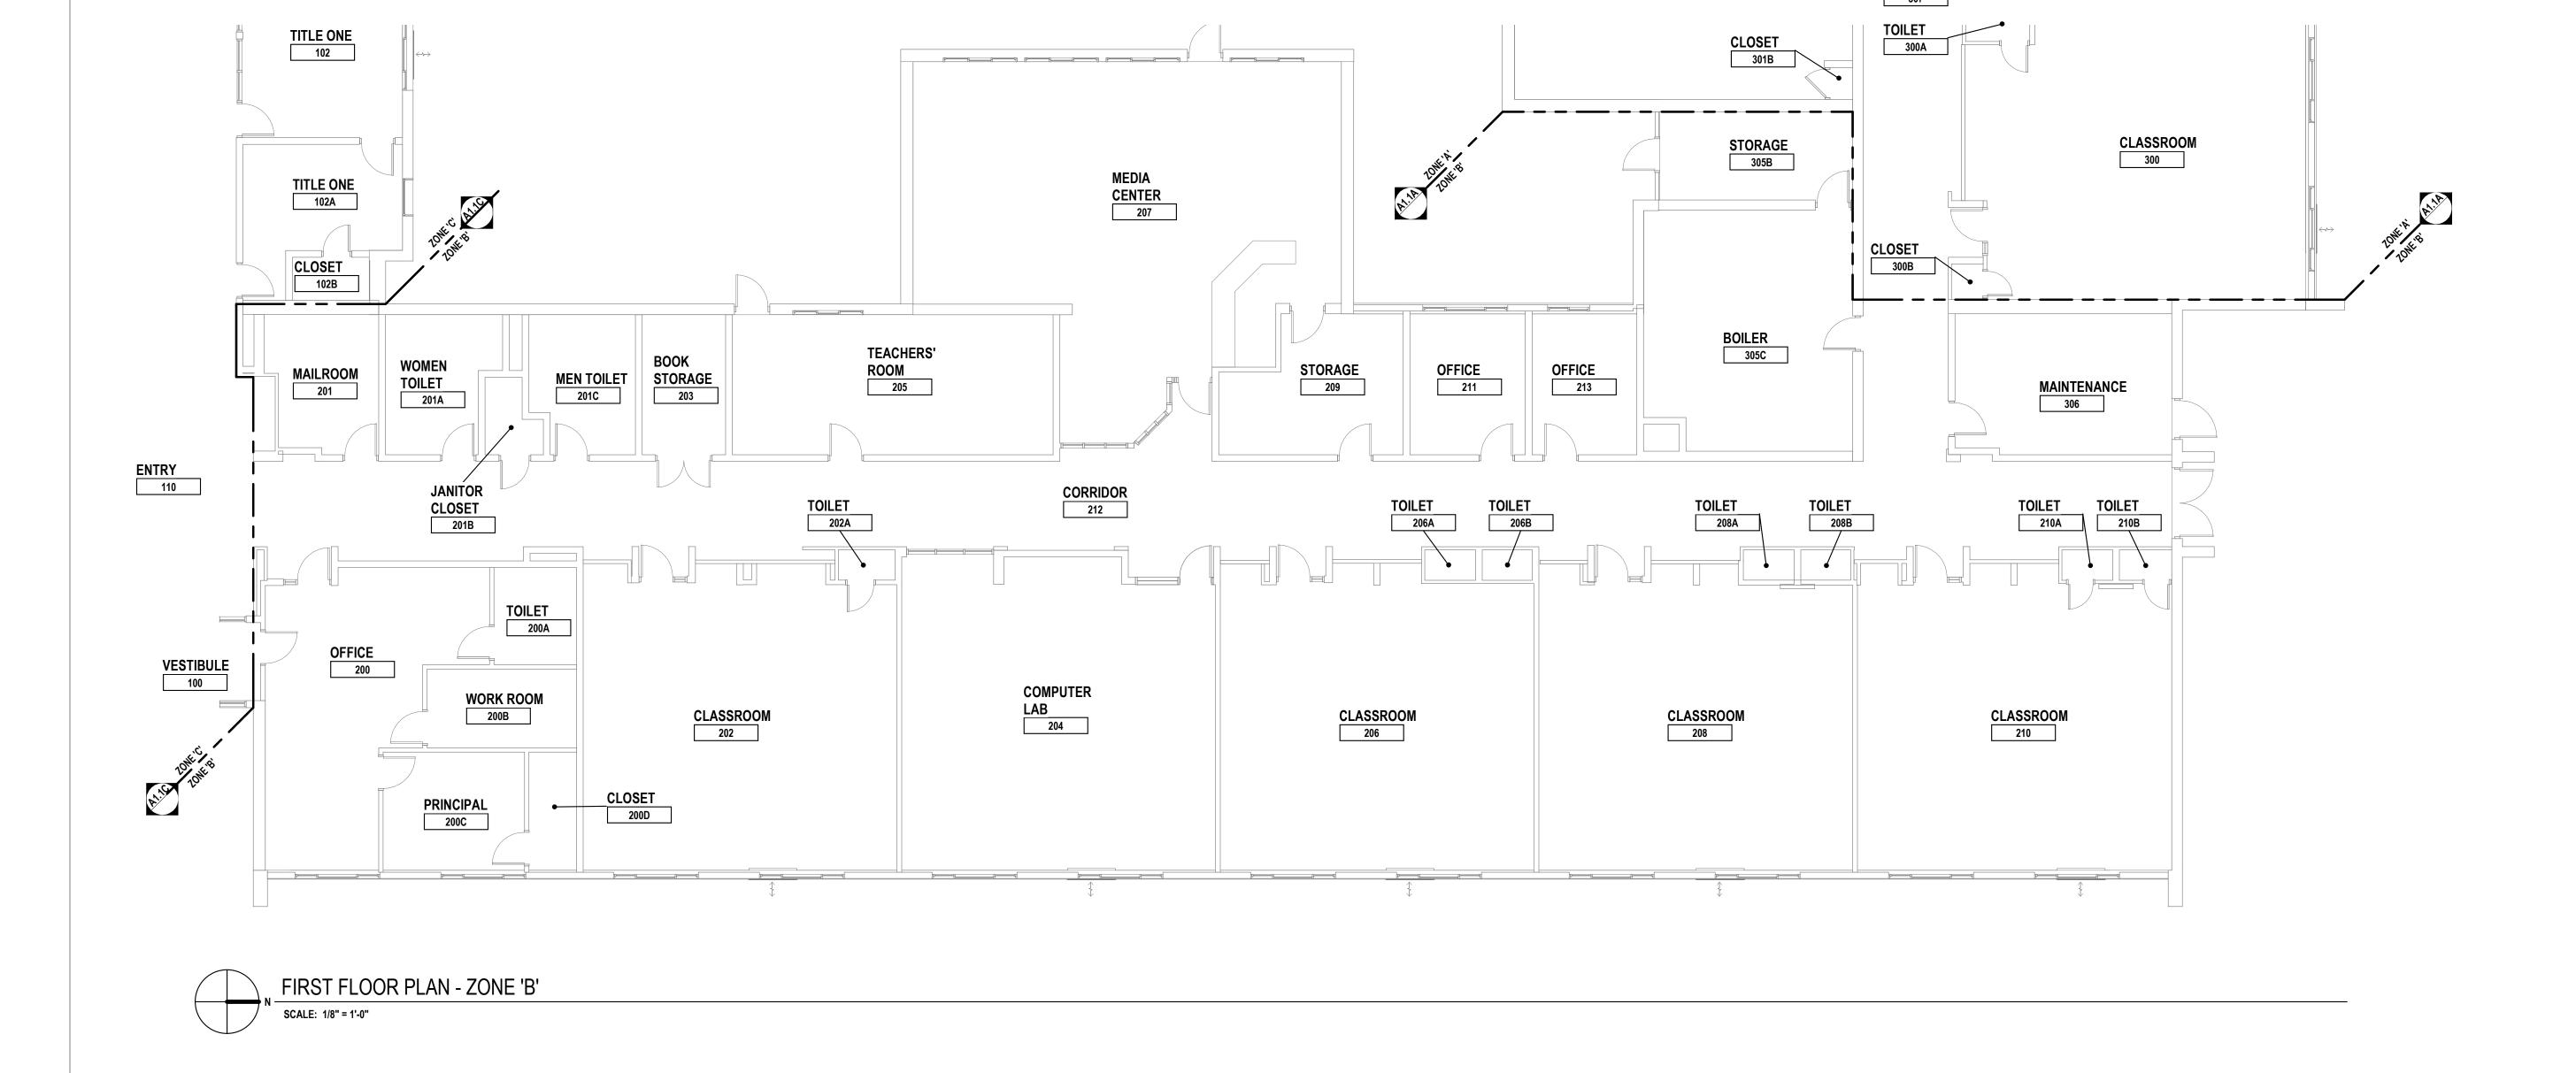LOCKER LEGEND

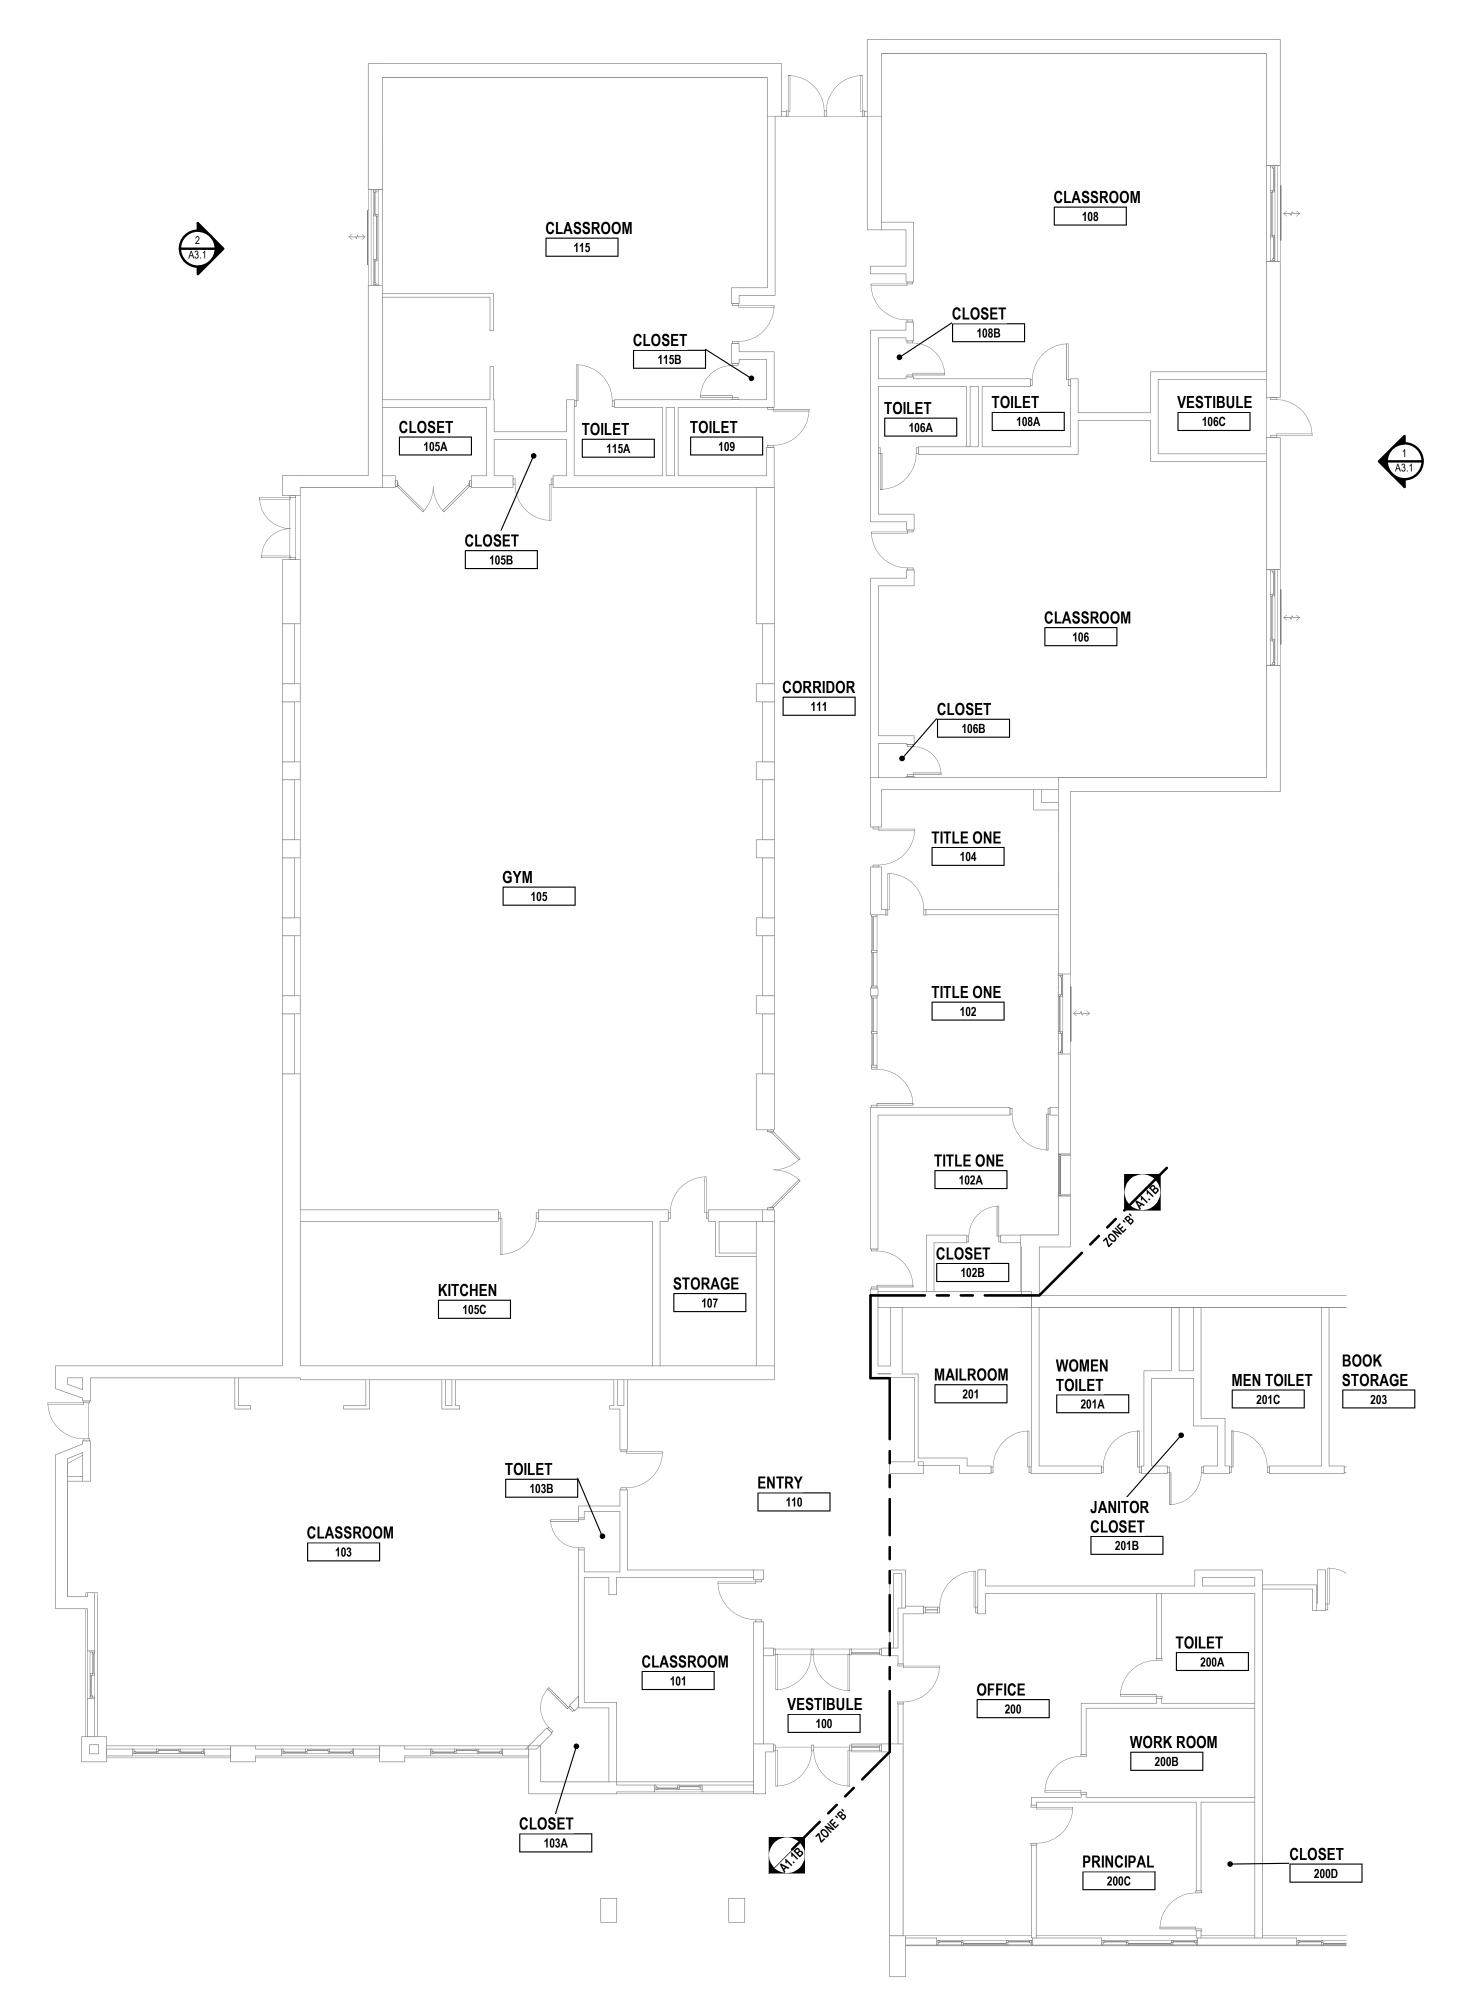SINGLE-TIER STANDARD LOCKERS (12" X 12" X 60" HIGH) VENTILATED, ON CONCRETE BASE (12 / A8.1)

L-1 SINGLE-TIER ADA ACCESSIBLE LOCKERS (12" X 12" X 60" HIGH) VENTILATED, ON CONCRETE BASE (12 / A8.1) (REFER TO PLANS FOR ADA LOCATIONS)

TYPE DOUBLE-TIER STANDARD LOCKERS (12" X 15" X 60" HIGH) VENTILATED, ON CONCRETE BASE (12 / A8.1)

NOTES:

1. PROVIDE CONTINUOUS SLOPED TOPS AT ALL LOCKERS (UON) 2. PROVIDE FILLER PIECES AT ENDS & CORNERS AS REQUIRED 3. SIZES INDICATED ABOVE REFER TO WIDTH x DEPTH x HEIGHT

WALL / PARTITION KEY

METAL STUD PARTITION

CMU PARTITION

(Aa) WALL / PARTITION LEGEND

2A 3 5/8" METAL STUDS @ 16" OC (MAX) W/ 5/8" GYP BOARD BOTH SIDES TO 6" ABOVE CEILING 2B 6" METAL STUDS @ 16" OC (MAX) W/ 5/8" GYP BOARD BOTH SIDES TO 6" ABOVE CEILING

4A 4" CMU TO ONE FULL COURSE ABOVE CEILING 4B 6" CMU TO ONE FULL COURSE ABOVE CEILING

4C 8" CMU TO ONE FULL COURSE ABOVE CEILING 4D 12" CMU TO ONE FULL COURSE ABOVE CEILING

4E 4" CMU TO STRUCTURE ABOVE 4F 6" CMU TO STRUCTURE ABOVE

4G 8" CMU TO STRUCTURE ABOVE 4H 12" CMU TO STRUCTURE ABOVE 4M 8" CMU TO STRUCTURE ABOVE - SMOKE PARTITION FOR EGRESS CORRIDORS

5C 8" CMU TO STRUCTURE ABOVE, 1HR FIRE PARTITION FOR STORAGE AND UTILITY ROOMS

6C 8" CMU TO STRUCTURE ABOVE, 2 HOUR RATED, UL DESIGN NO. U905 6D FIRE WALL: 12" CMU TO STRUCTURE ABOVE, 2 HOUR RATED, UL DESIGN NO. U905

7C 8" CMU TO STRUCTURE ABOVE, 3 HOUR RATED, UL DESIGN NO. U904

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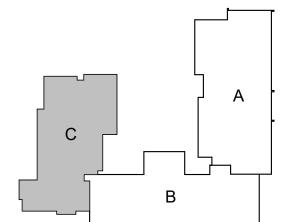
PROJECT TITLE

Washington **Elementary School** Addition and Renovations

CHARLOTTE PUBLIC SCHOOLS CHARLOTTE, MI

DRAWING TITLE

First Floor Plan - Zone 'C'



KEYPLAN

issue dates **DESIGN DEVELOPMENT**

project no.

20104

drawing no. A1.1C

GENERAL NOTES

INDICATED ON DRAWINGS.

GYPSUM BOARD) IS INTENDED TO BE FLUSH WITH CMU.

TERMINATION AT EXISTING SMOKE-RESISTING WALLS.

SUBSTRATE IN LIEU OF GYPSUM BOARD.

1. COORDINATE SIZE AND LOCATION OF ALL CONCRETE HOUSEKEEPING PADS AND/OR EQUIPMENT SUPPORTS WITH APPROPRIATE EQUIPMENT MANUFACTURER.

2. COORDINATE SIZE AND LOCATION OF ALL ACCESS PANELS WITH TRADE REQUIRING THE SAME. ACCESS PANELS ARE SPECIFIED ARCHITECTURALLY BUT ARE REQUIRED TO BE PROVIDED BY EACH TRADE. ALL LOCATIONS MUST BE COORDINATED AND APPROVED BY THE ARCHITECT'S FIELD REPRESENTATIVE.

1. ALL GYPSUM WALLS TO RECEIVE ABUSE RESISTANT GYPSUM BOARD BELOW 4'-0" AFF, TYPICAL 2. REFER TO MASONRY SPECIFICATION FOR VERTICAL REINFORCEMENT AND WALL BRACING NOT

3. PROVIDE BULLNOSE CMU UNITS AT ALL OUTSIDE CORNERS WHEN CORNERS ARE EXPOSED IN FINAL CONSTRUCTION. DO NOT BULLNOSE CORNERS WHEN ABUTTING CONSTRUCTION (i.e.

4. WHERE FINISH PLANS (A10 SERIES DRAWINGS) CALL FOR WALL TILE, PROVIDE CEMENT BOARD

5. COORDINATE WITH THE REFLECTED CEILING PLANS FOR RATED WALLS, WALLS WHICH EXTEND UP TO THE STRUCTURE ABOVE AND WALLS WHICH EXTEND ONLY A MINIMUM OF 4" ABOVE THE ADJACENT HIGHEST CEILING. REFER TO BUILDING SECTIONS, WALL SECTIONS AND INTERIOR ELEVATIONS FOR BANDING OF SPECIAL CMU TYPES OR ANY OTHER SPECIAL CONDITIONS.

6. AT FIRE-RATED AND SMOKE-RESISTING WALLS (MASONRY OR GYPSUM BOARD), PROVIDE U.L. APPROVED, FIRE-RATED, HEAD-OF-WALL TERMINATIONS AS INDICATED. IF NOT INDICATED, PROVIDE "BASIS OF DESIGN", HEAD-OF-WALL FIRESTOP JOINT SYSTEM AS INDICATED IN SPECIFICATION SECTION 078446 (1 OR 2 HOUR AS APPROPRIATE). PROVIDE MINIMUM 1 HOUR

7. ALL DOORS LOCATED 4" FROM JAMB TO ADJACENT WALL UNLESS OTHERWISE INDICATED.

PARTIAL HEIGHT CMU WALLS WILL BE NOTED AS SUCH ON THE FLOOR PLANS.

3. CONTRACTORS SHALL VERIFY ALL EXISTING BUILDING DIMENSIONS, PARTITION AND WALL LOCATIONS, AND FLOOR ELEVATIONS IN THE FIELD AND NOTIFY THE ARCHITECTS REPRESENTATIVE OF ANY DISCREPANCIES BEFORE START OF WORK.

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7. PROVIDE CONTROL JOINTS WHERE INTERIOR CMU (ON SLAB) ABUTS EXTERIOR/INTERIOR MASONRY (ON FOUNDATIONS OR FOOTINGS).

8. VERIFY QUANTITY, SIZE, AND LOCATION OF ALL FLOOR, ROOF, AND WALL OPENINGS FOR MECHANICAL AND ELECTRICAL WORK WITH THE APPROPRIATE TRADE. PROVIDE ALL OPENINGS SHOWN OR REQUIRED FOR THE COMPLETION OF THE WORK. PROVIDE ALL

LINTELS REQUIRED FOR THESE OPENINGS PER SPECIFICATIONS.

9. REFER TO LIFE SAFETY PLANS FOR LOCATIONS OF REQUIRED FIRE RESISTANCE RATINGS. BECAUSE OF THE DRAWING SCALE OF THE LIFE SAFETY PLANS, COORDINATE THE REQUIRED FIRE RESISTANCE RATINGS WITH THOSE SHOWN ON THE REFLECTED CEILING

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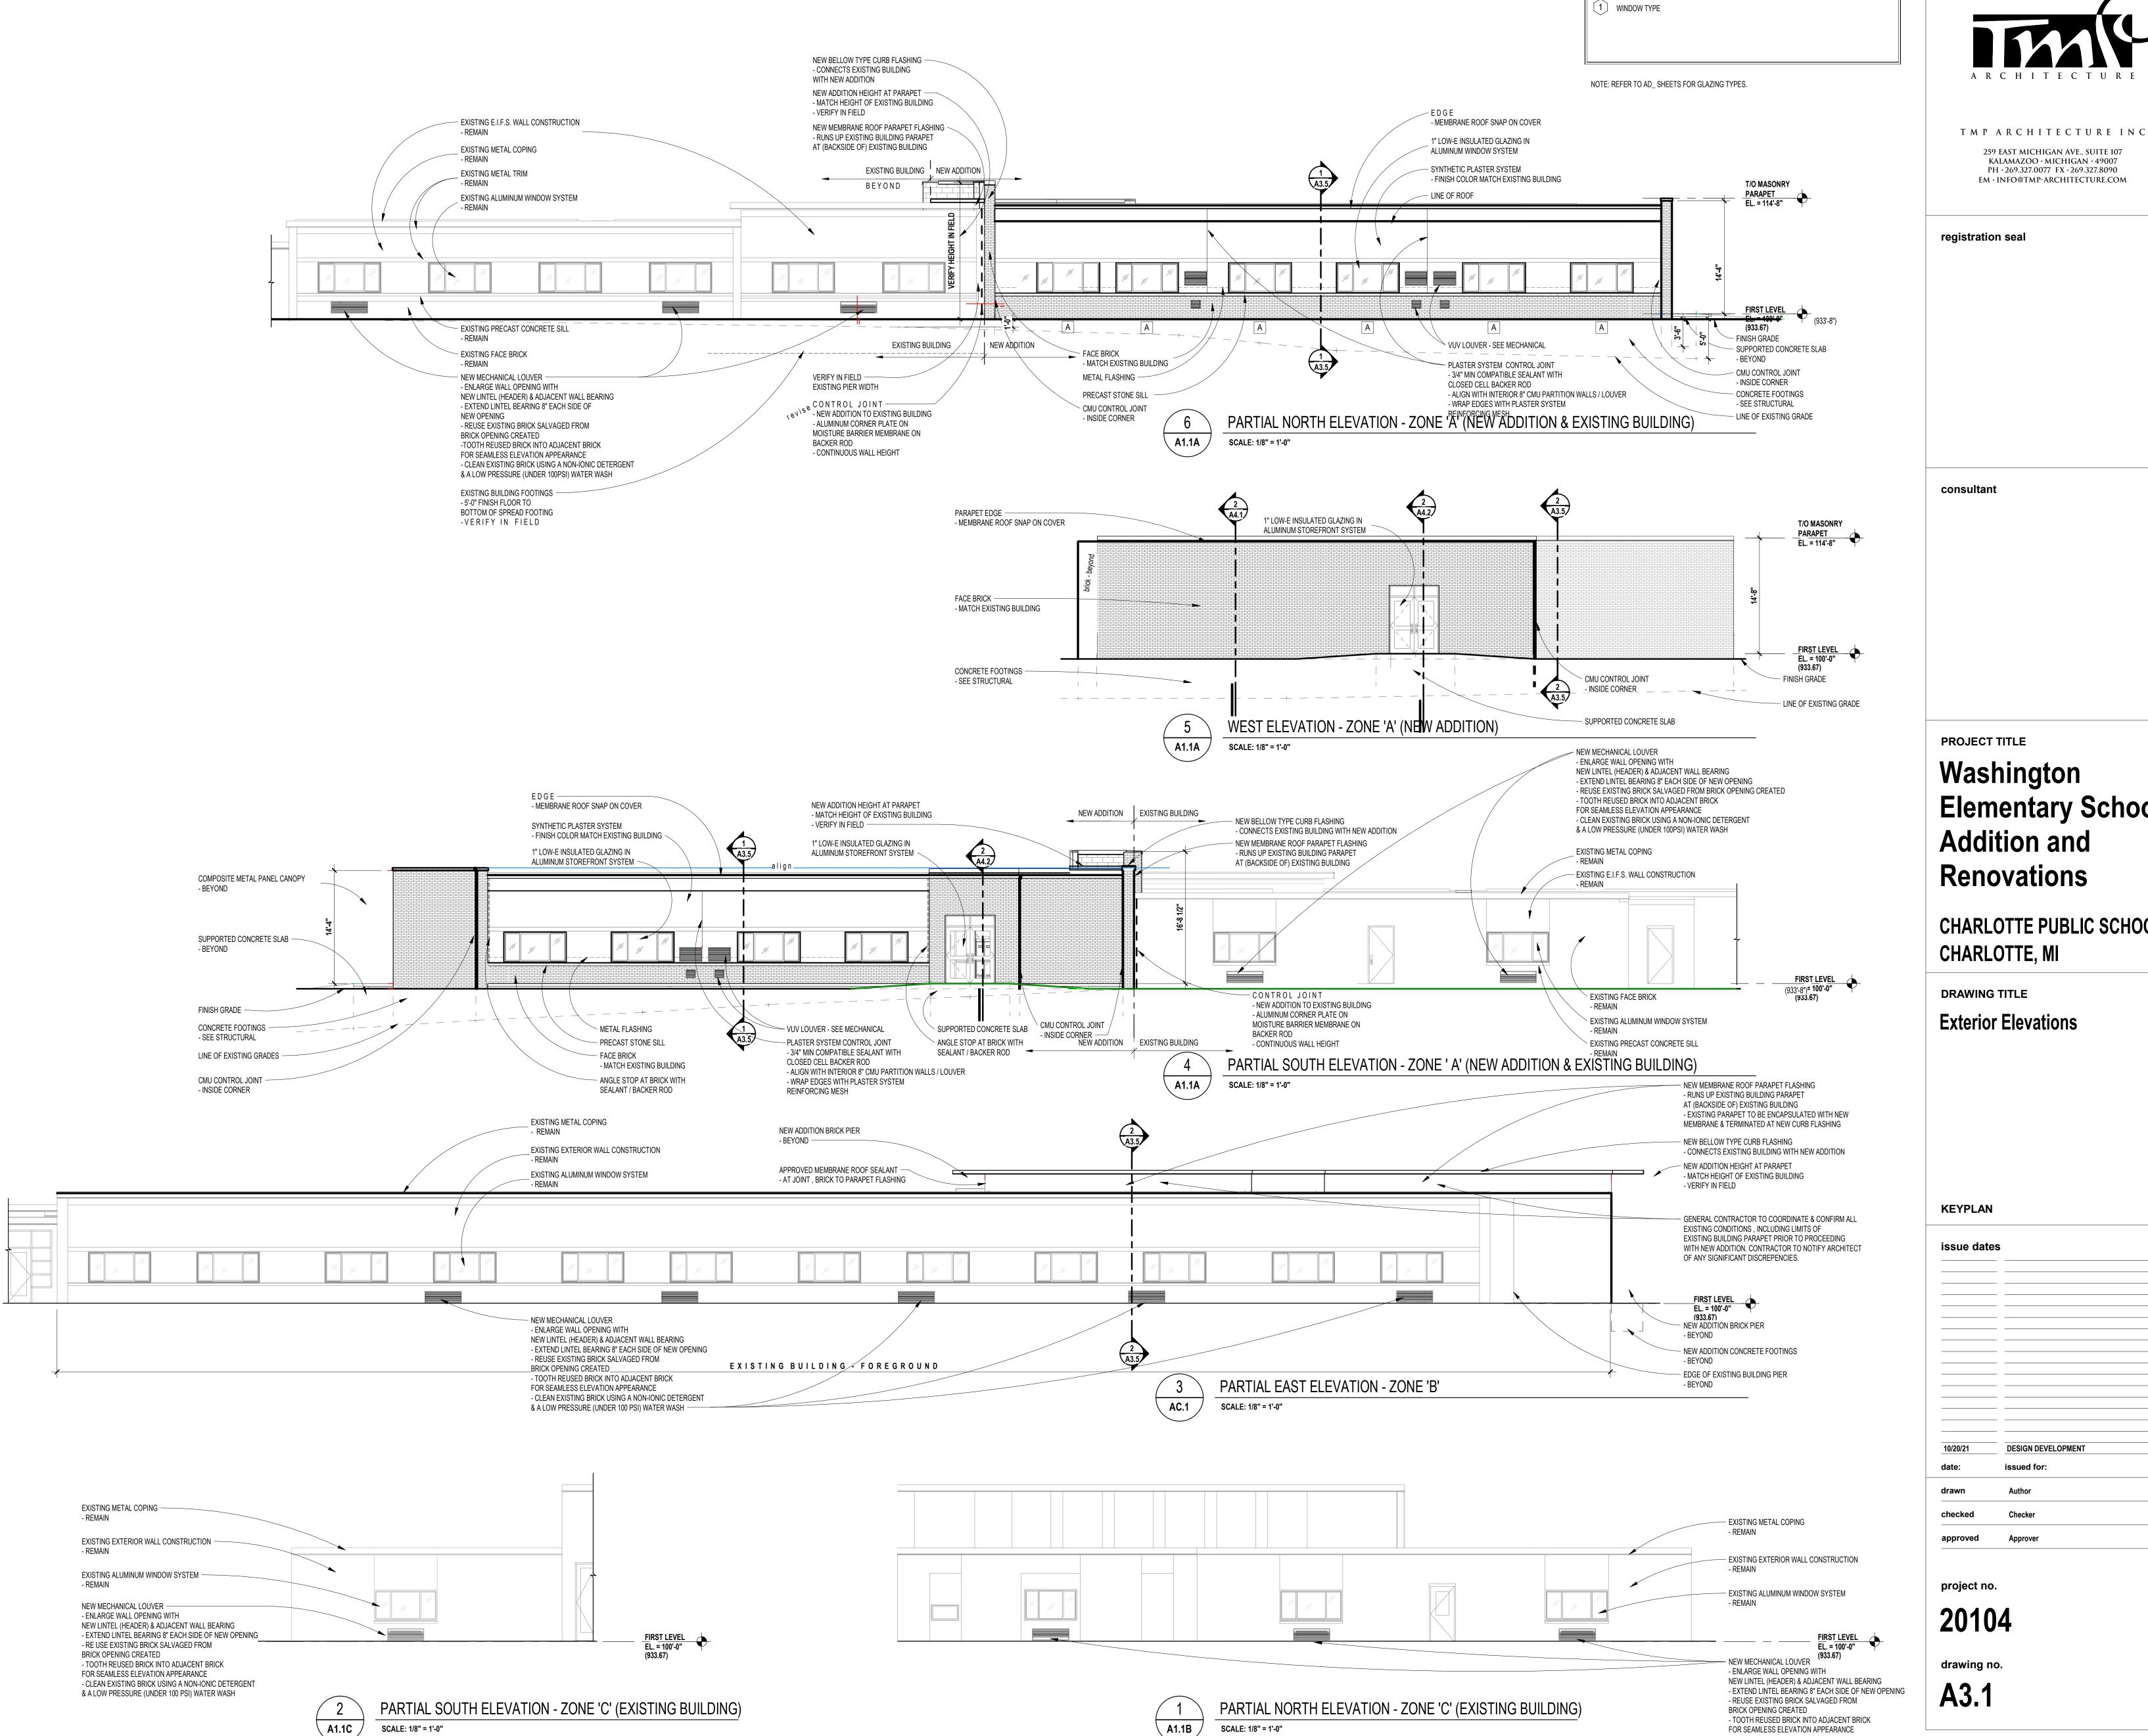
14. VERIFY ALL DIMENSIONS IN FIELD.

EXTERIOR WALLS.

5. PROVIDE WOOD BLOCKING WITHIN STUD WALLS FOR WALL MOUNTED ITEMS i.e. GRAB BARS, TOWEL DISPENSERS, PENCIL SHARPENERS, WALL STOPS, ACCORDIAN PARTITION JAMBS, ETC. REFER ALSO TO A9._ SERIES AND A6._ SERIES DRAWINGS.

16. REFER TO EXTERIOR ELEVATIONS AND PLAN DETAILS FOR LOCATIONS OF CONTROL JOINTS IN EXTERIOR WALLS.

17. CONTRACTOR TO COORDINATE LOCATIONS OF COMM. / ELEC. RECEPTACLES BASE ON CLASSROOM ELEVATIONS W/ ARCH EQUIPMENT AND NOTIFY ARCHITECT'S REPRESENTATIVE



SYMBOL LEGEND

Washington Elementary School Addition and Renovations


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FOR SEAMLESS ELEVATION APPEARANCE

- CLEAN EXISTING BRICK USING A NON-IONIC DETERGENT & A LOW PRESSURE (UNDER 100 PSI) WATER WASH

Charlotte High School



SITE BM#101 CHISELED "+" ON SIDE OF LIGHT POLE BASE LOCATED IN EAST ASHP PARKING LOT +/-90' SE OF THE SE BLDG COR OF CHARLOTTE HIGH SCHOOL

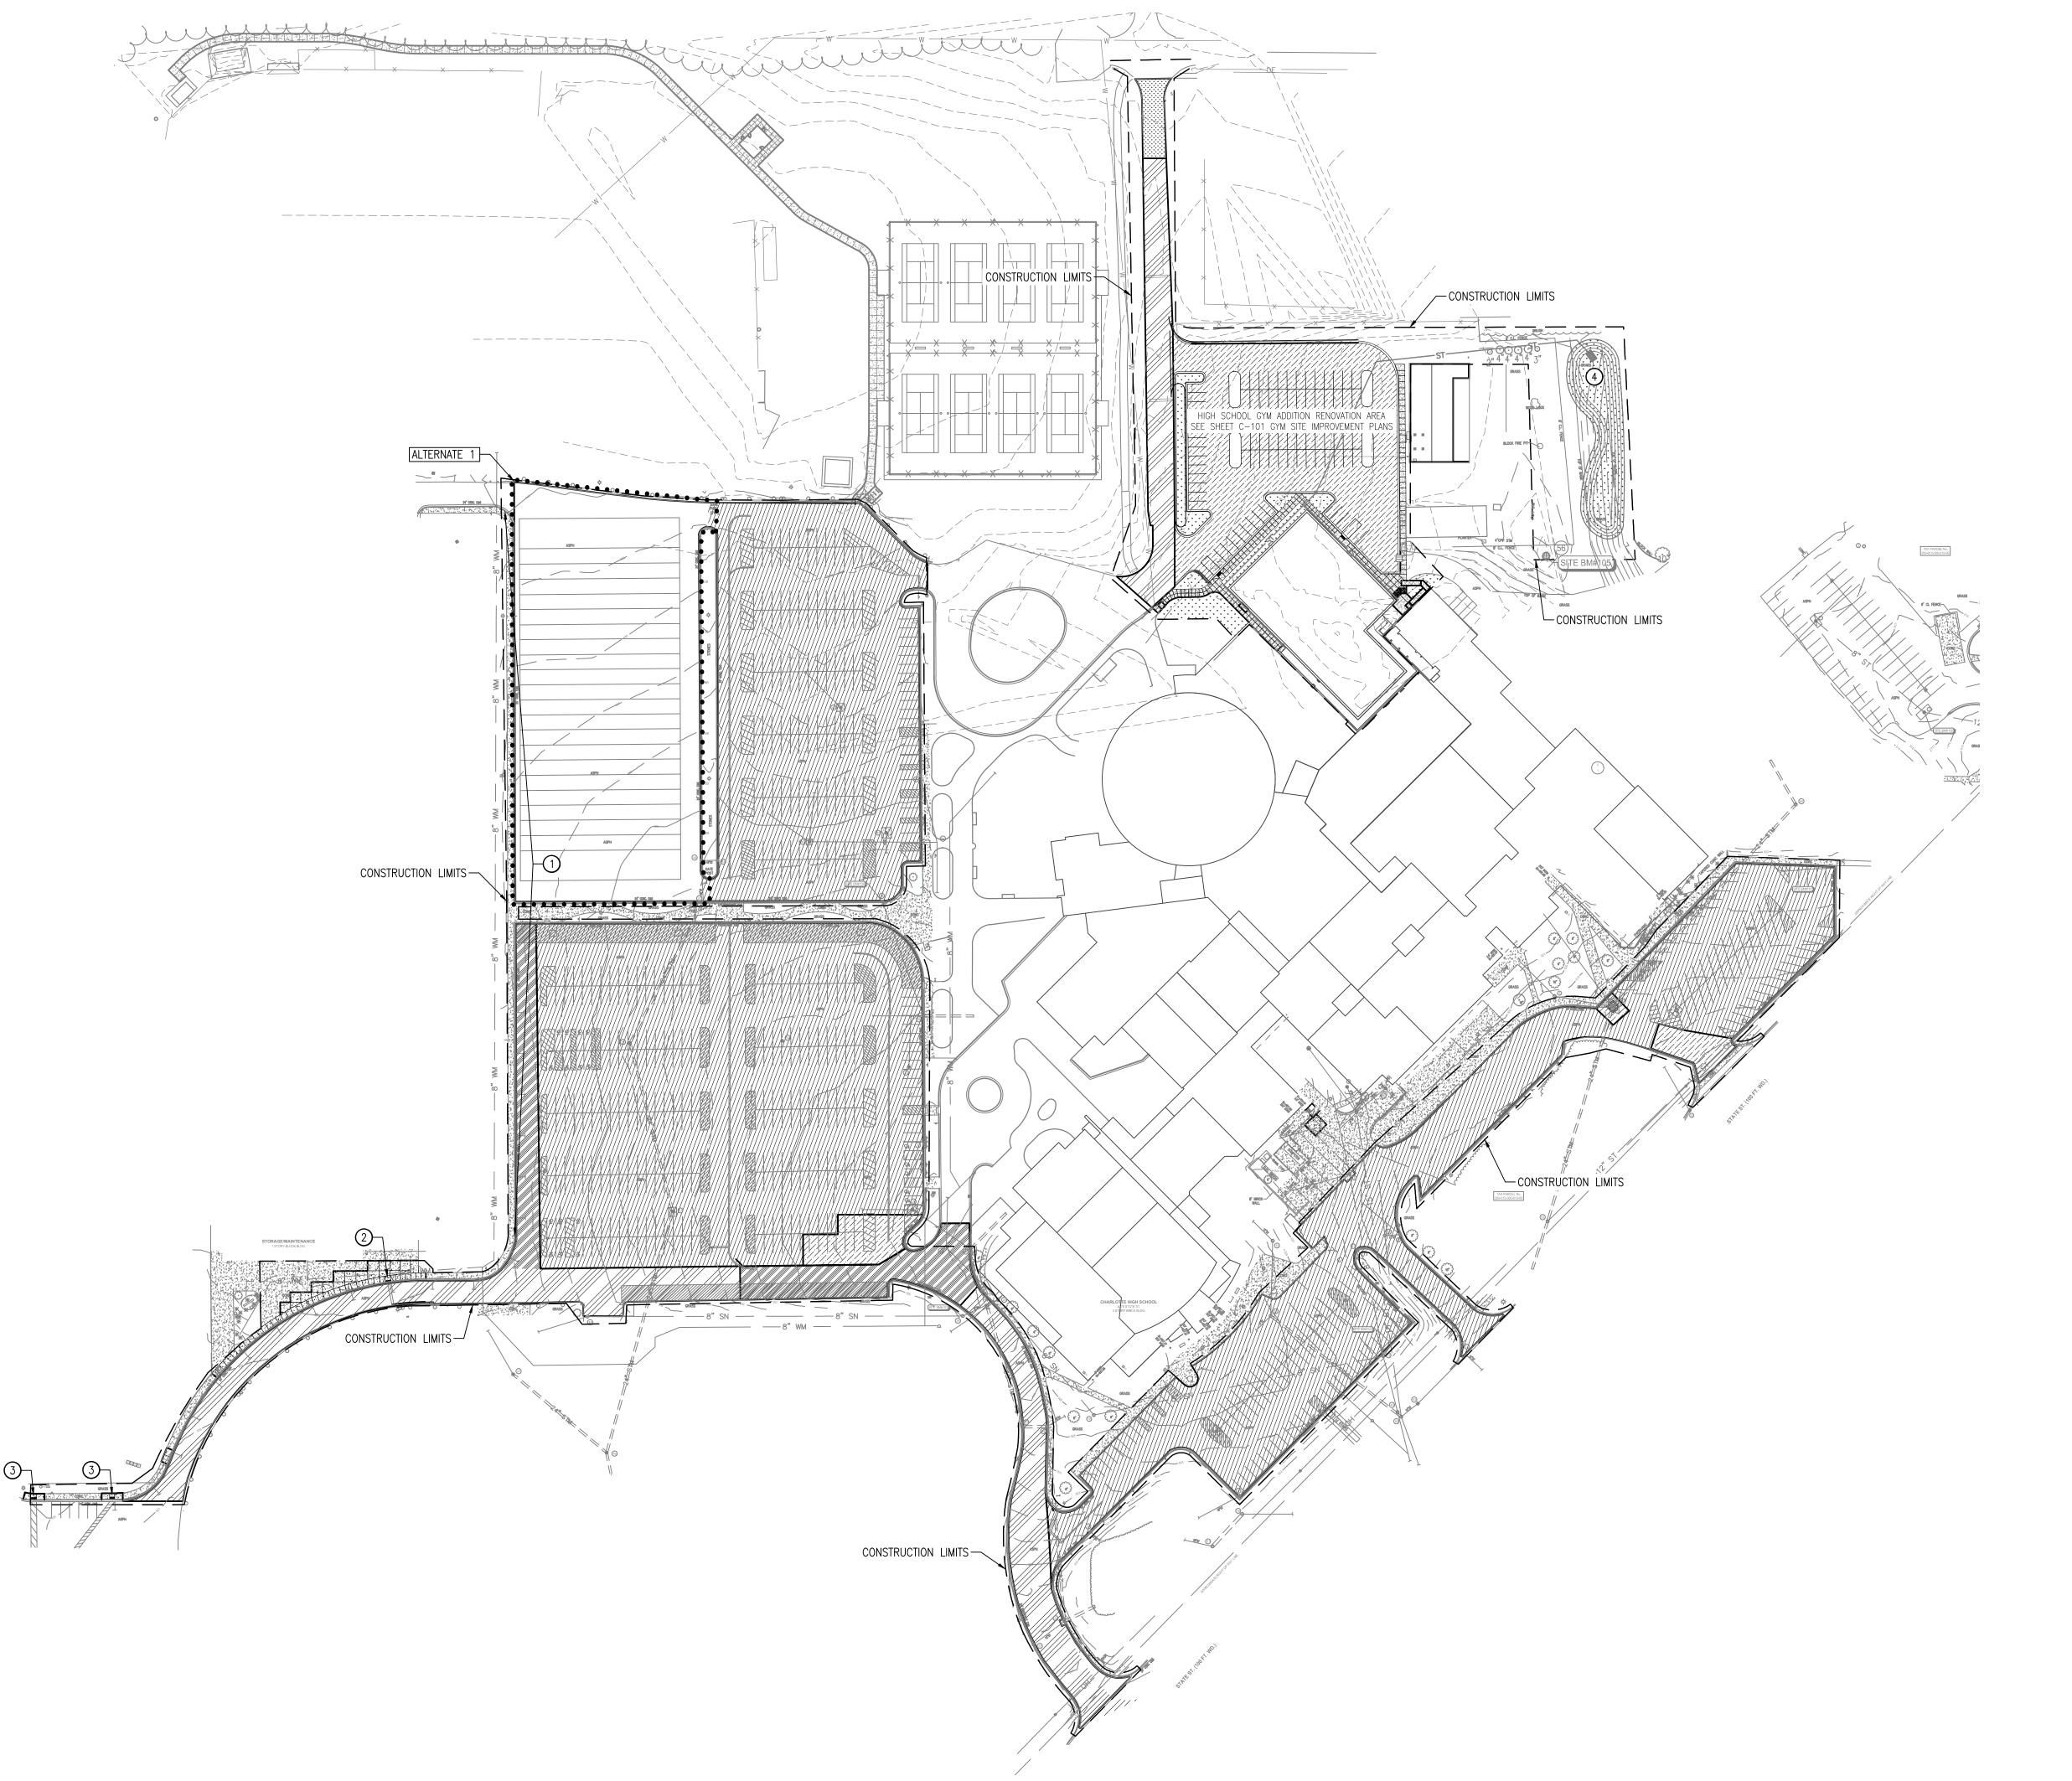ELEV.=921.39

SITE BM#102 CHISELED "+" ON NW RIM OF MANHOLE (STR. #13) LOCATED +/-69' SOUTHWEST OF MIDDLE DRIVEWAY ENTRANCE ELEV.=923.39

SITE BM#103 CHISELED "+" ON NORTH RIM OF MANHOLE (STR. #26)
LOCATED +/-46' SOUTHWEST OF WESTERLY BLDG COR &
+/-4' SOUTHWEST OF CURB TO SOUTH DRIVEWAY
ELEV.=928.14

SITEBM#104 CHISELED "+" ON NORTH RIM OF SQ. CATCH BASIN (STR #38) LOCATED IN SOUTH CURB OF THE NW ASPH PARKING

LOT +/-176' WEST OF BLDG FACE

DATUM: GPS-DERIVED NAVD'88

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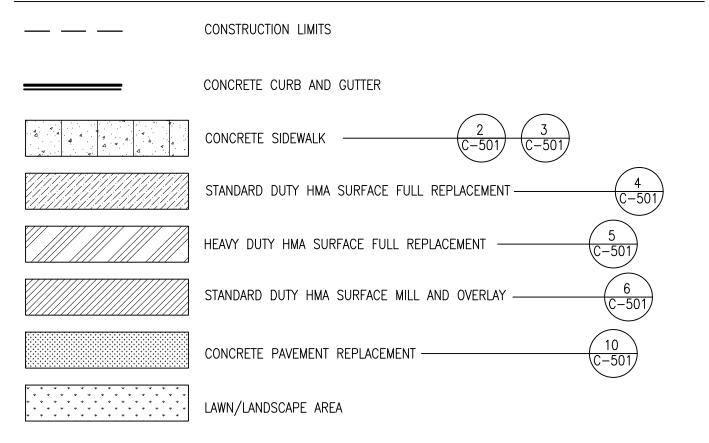
REGISTRATION SEAL

TMP ARCHITECTURE INC

1191 WEST SQUARE LAKE ROAD

BLOOMFIELD HILLS · MICHIGAN · 48302

SITE IMPROVEMENT LEGEND



SITE IMPROVEMENT KEY

- 1) APPLY JOINT SEALANT COMPOUND BETWEEN EX. CONCRETE SIDEWALK AND CURB
- 2 INSTALL TYPE F ADA RAMP
- 3 INSTALL TYPE P ADA RAMP
- 4 DETENTION BASIN

SITE IMPROVEMENT NOTES

- ALL AREAS SHOWN NOT BUILT, PAVED OR OTHERWISE COVERED BY CONSTRUCTION SHALL BE HYDROMULCH SEEDED, REFER TO SPECS FOR DETAILS.
- ALL AREAS DISTURBED BY CONSTRUCTION WHICH ARE OUTSIDE
- 2. ALL AREAS DISTURBED BY CONSTRUCTION WHICH ARE OUTSIDE THE CONSTRUCTION LIMITS SHALL BE RESTORED TO A CONDITION EQUAL TO, OR BETTER THAN EXISTING CONDITIONS.

3. THE SITE CONTRACTOR SHALL COORDINATE WORK WITH ALL ADJACENT CONSTRUCTION BY OTHERS.

- 4. ALL GRADES ARE TO MATCH EXISTING AT LIMITS OF DEMOLITION.
- 5. NEWLY SURFACED OR REPLACED PAVEMENTS SHALL BE STRIPED TO MATCH EXISTING.

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Remodeling


Charlotte Public Schools


DRAWING TITLE Overall Site Improvements Plan

ISSUE DATES

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BENCHMARKS

BM #200 - BOLT OF LIGHT POLE N.W. OF DOME PORTION OF HIGH SCHOOL BUILDING, EAST OF SIDEWALK AND DRIVE.

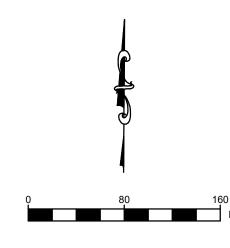NAVD88 EL. 937.32

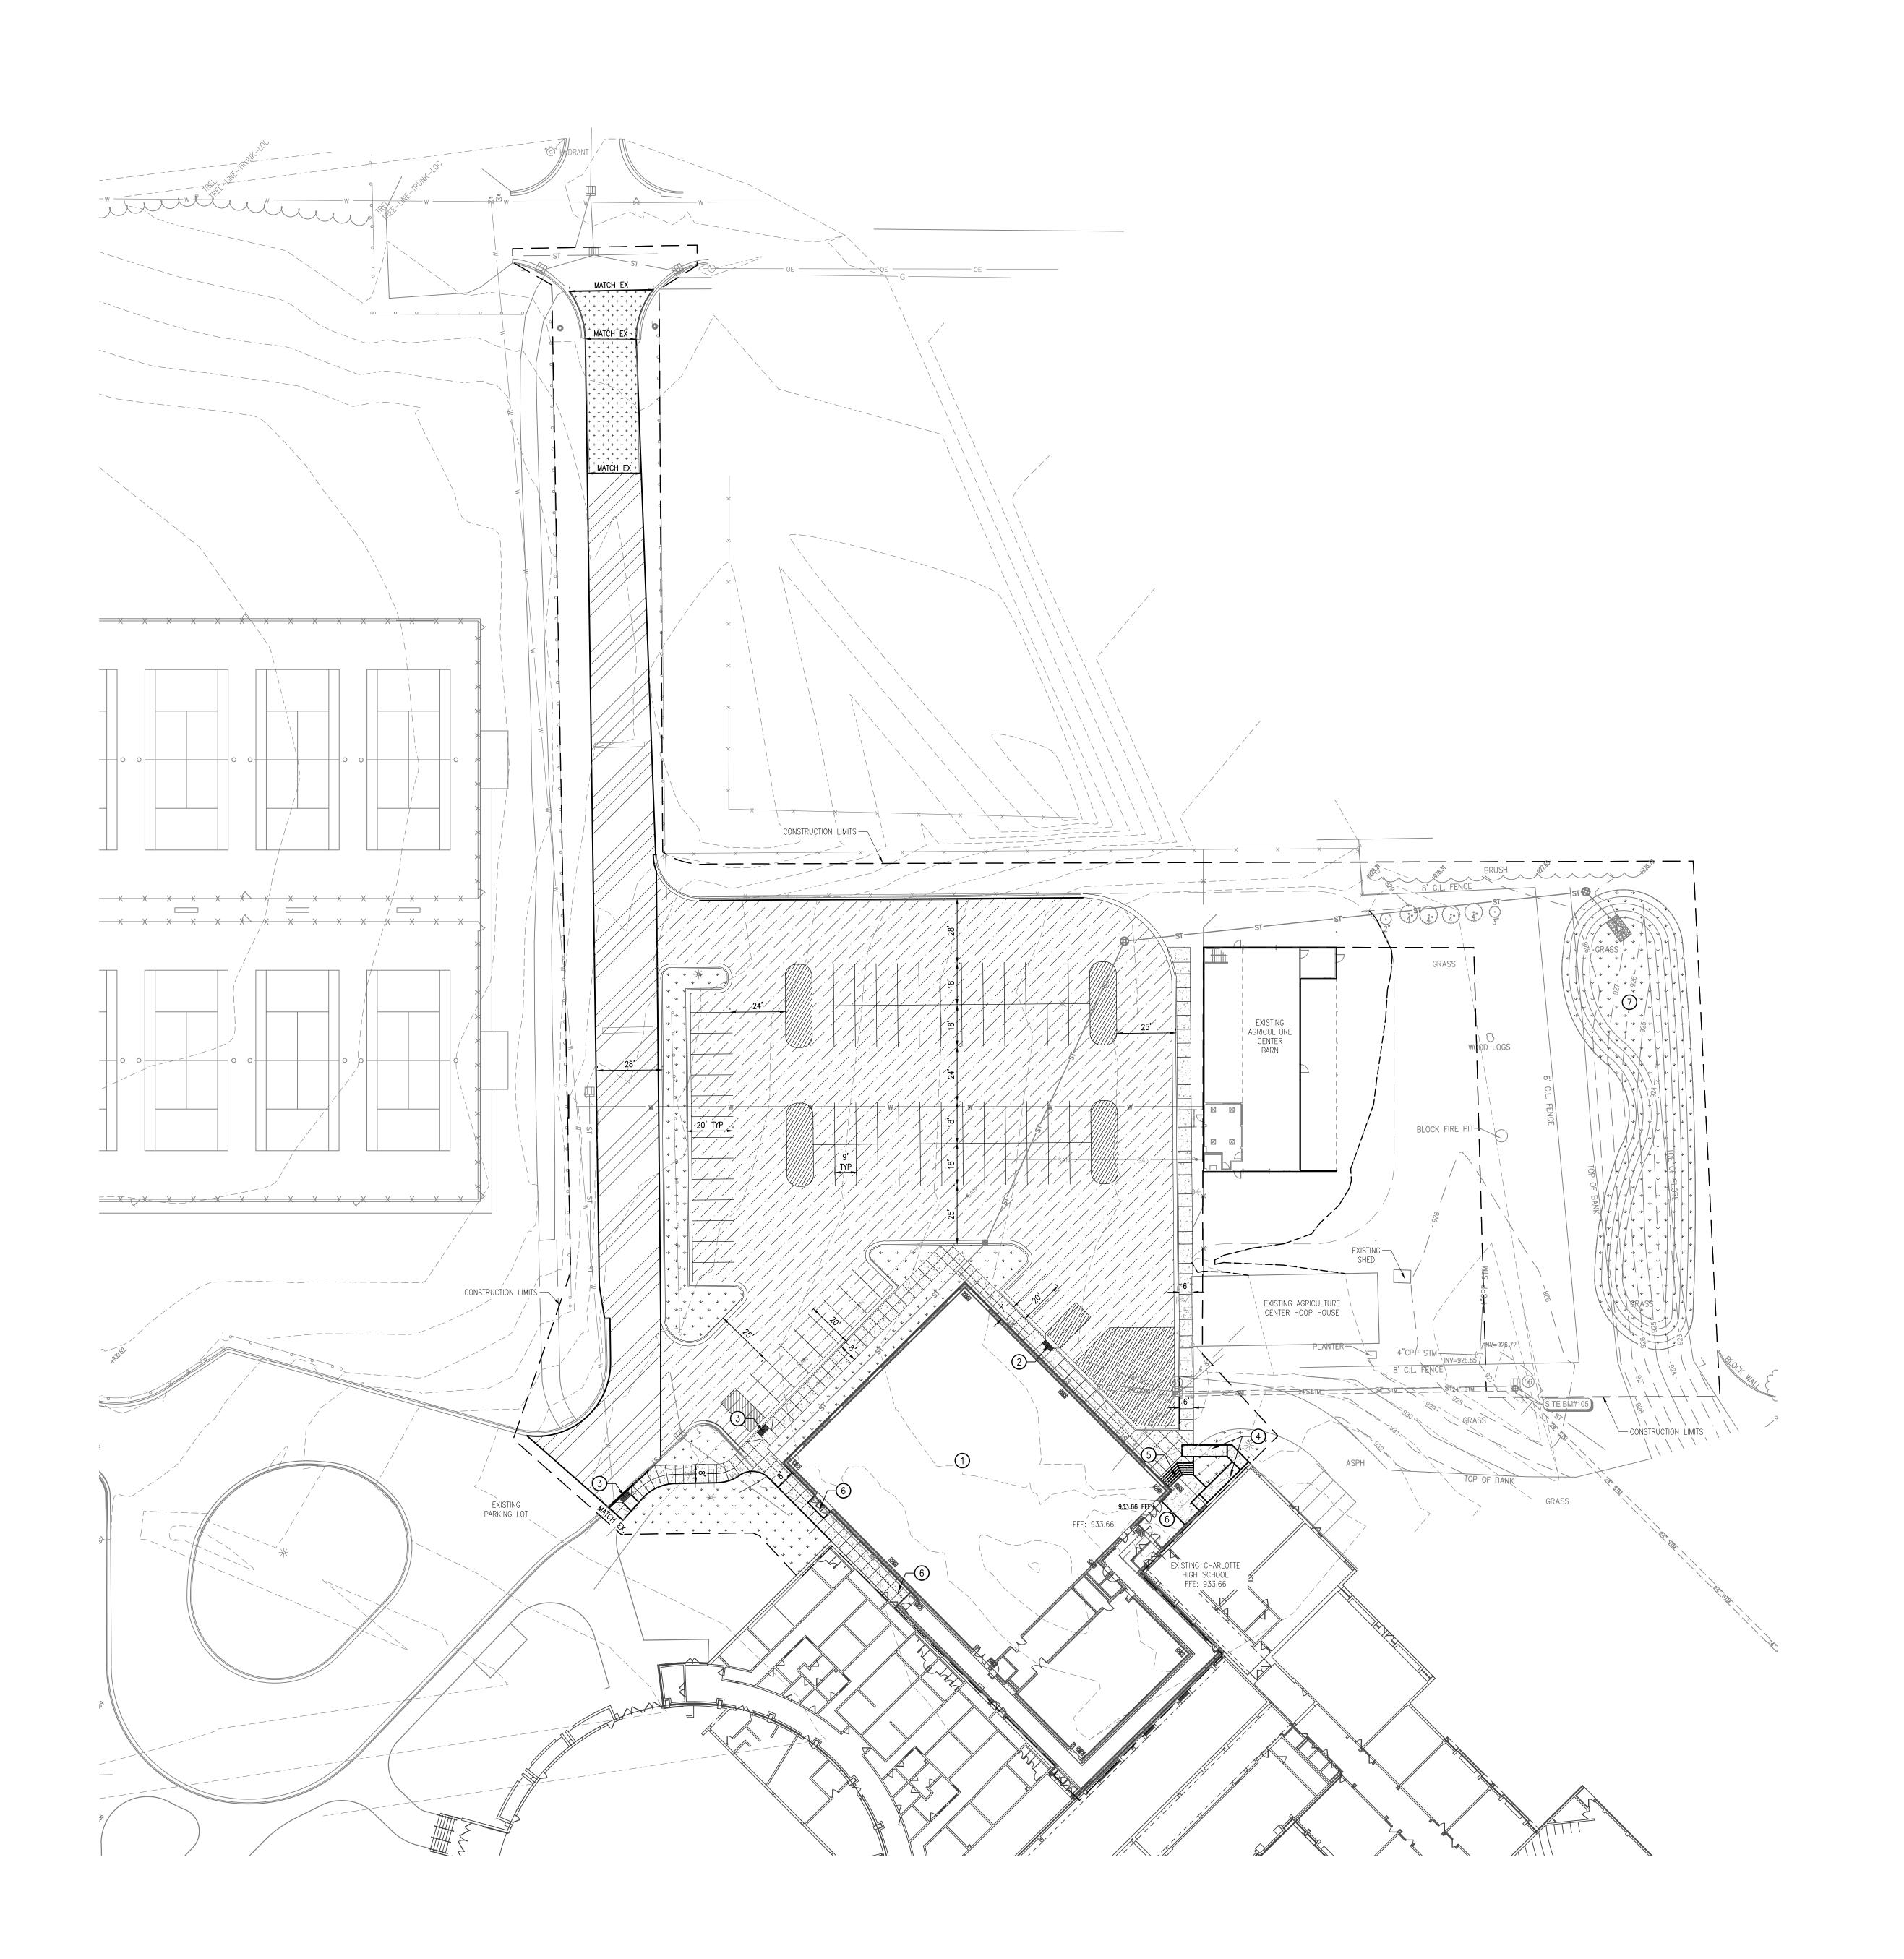SITE IMPROVEMENT LEGEND

___ _ CONSTRUCTION LIMITS

PERMANENT SEEDING

4 PROPOSED RAMP ENTRY

5 PROPOSED STAIR ENTRY

PARKING

PROPOSED PARKING SPACES: 84
REQUIRED ADA: 4

7 PROPOSED DETENTION POND

SITE IMPROVEMENT KEY

1 BUILDING ADDITION. REFER TO ARCH PLANS.

2 PROPOSED MDOT TYPE P ADA SIDEWALK RAMP

3 PROPOSED MDOT TYPE F ADA SIDEWALK RAMP

6 PROPOSED ENTRY STOOP; SEE STRUCTURAL PLANS

SITE IMPROVEMENT NOTES

SEE OVERALL SITE IMPROVEMENTS FOR GENERAL SITE IMPROVEMENT NOTES AND PERMANENT SESC NOTES, INCLUDING PERMANENT SEEDING NOTES.



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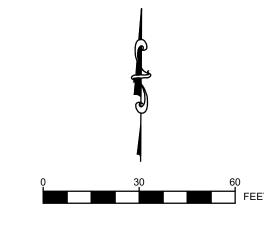
Gym Addition Site Improvements Plan


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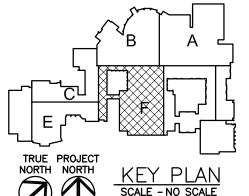
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DRAWING TITLE **Basement Level** Floor Plan - Zone 'F'




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WALL / PARTITION KEY

EXISTING WALL CONSTRUCTION

METAL STUD PARTITION

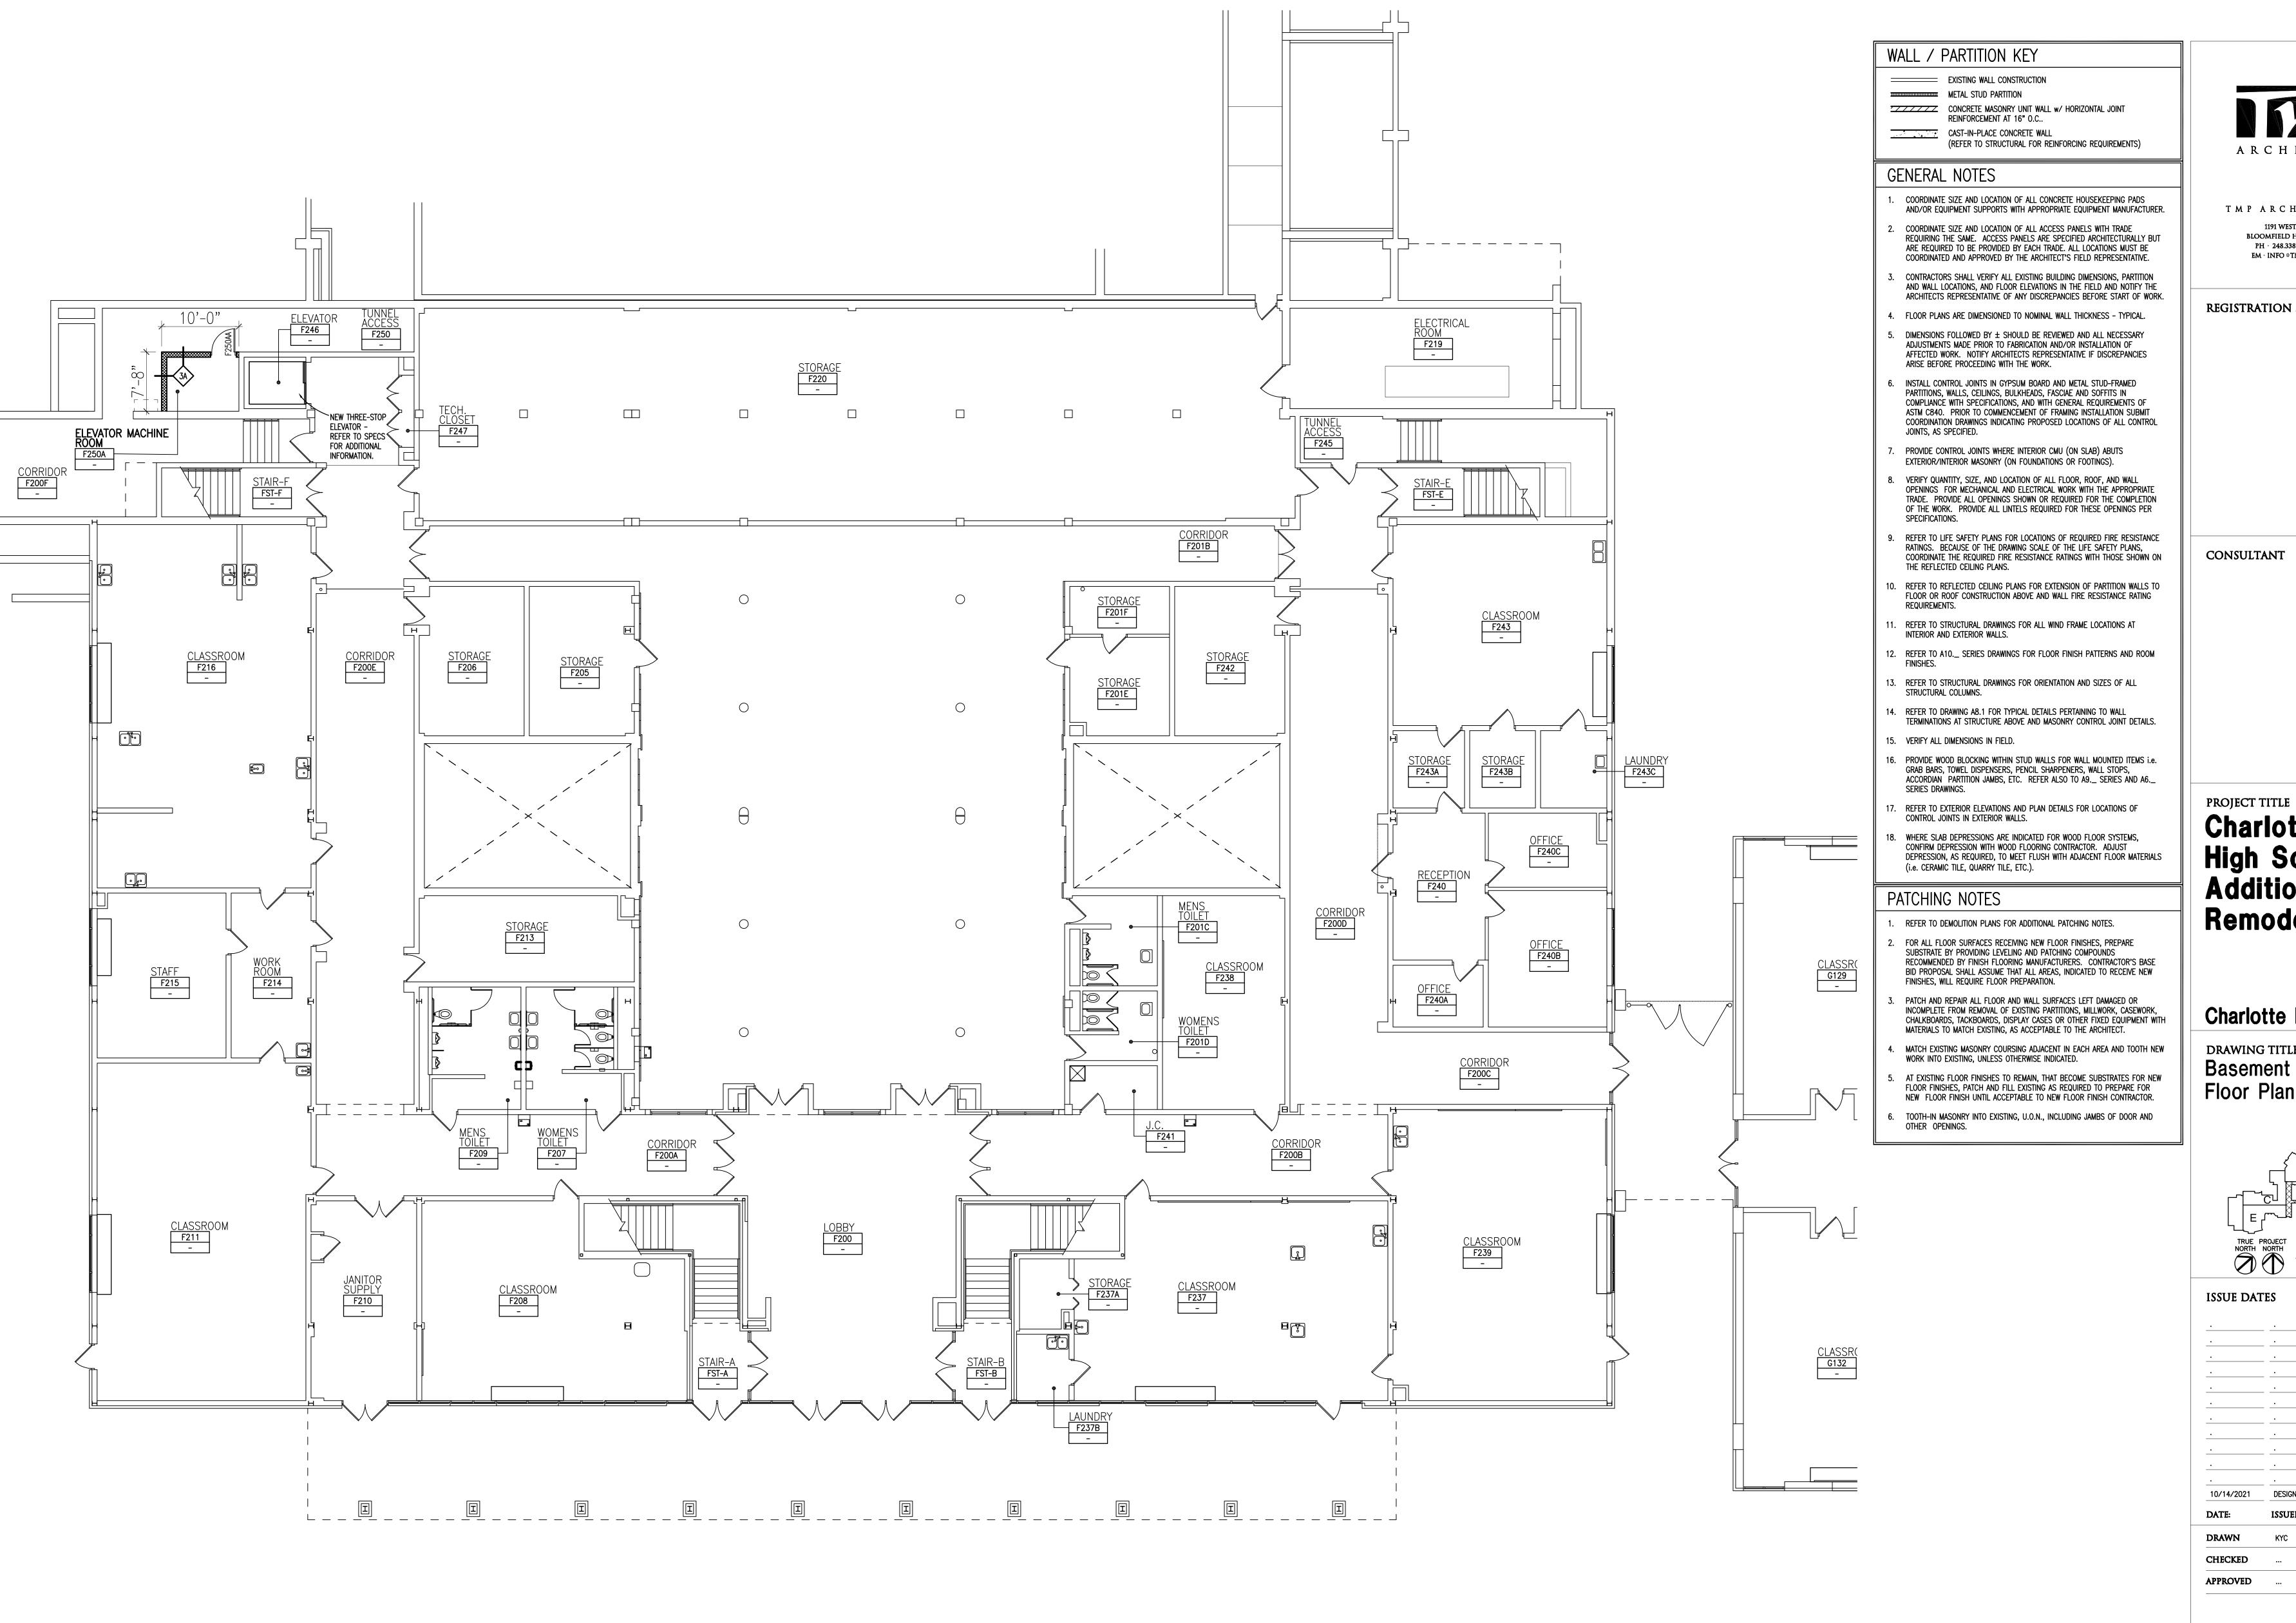CONCRETE MASONRY UNIT WALL w/ HORIZONTAL JOINT REINFORCEMENT AT 16" O.C..

CAST-IN-PLACE CONCRETE WALL
(REFER TO STRUCTURAL FOR REINFORCING REQUIREMENTS)

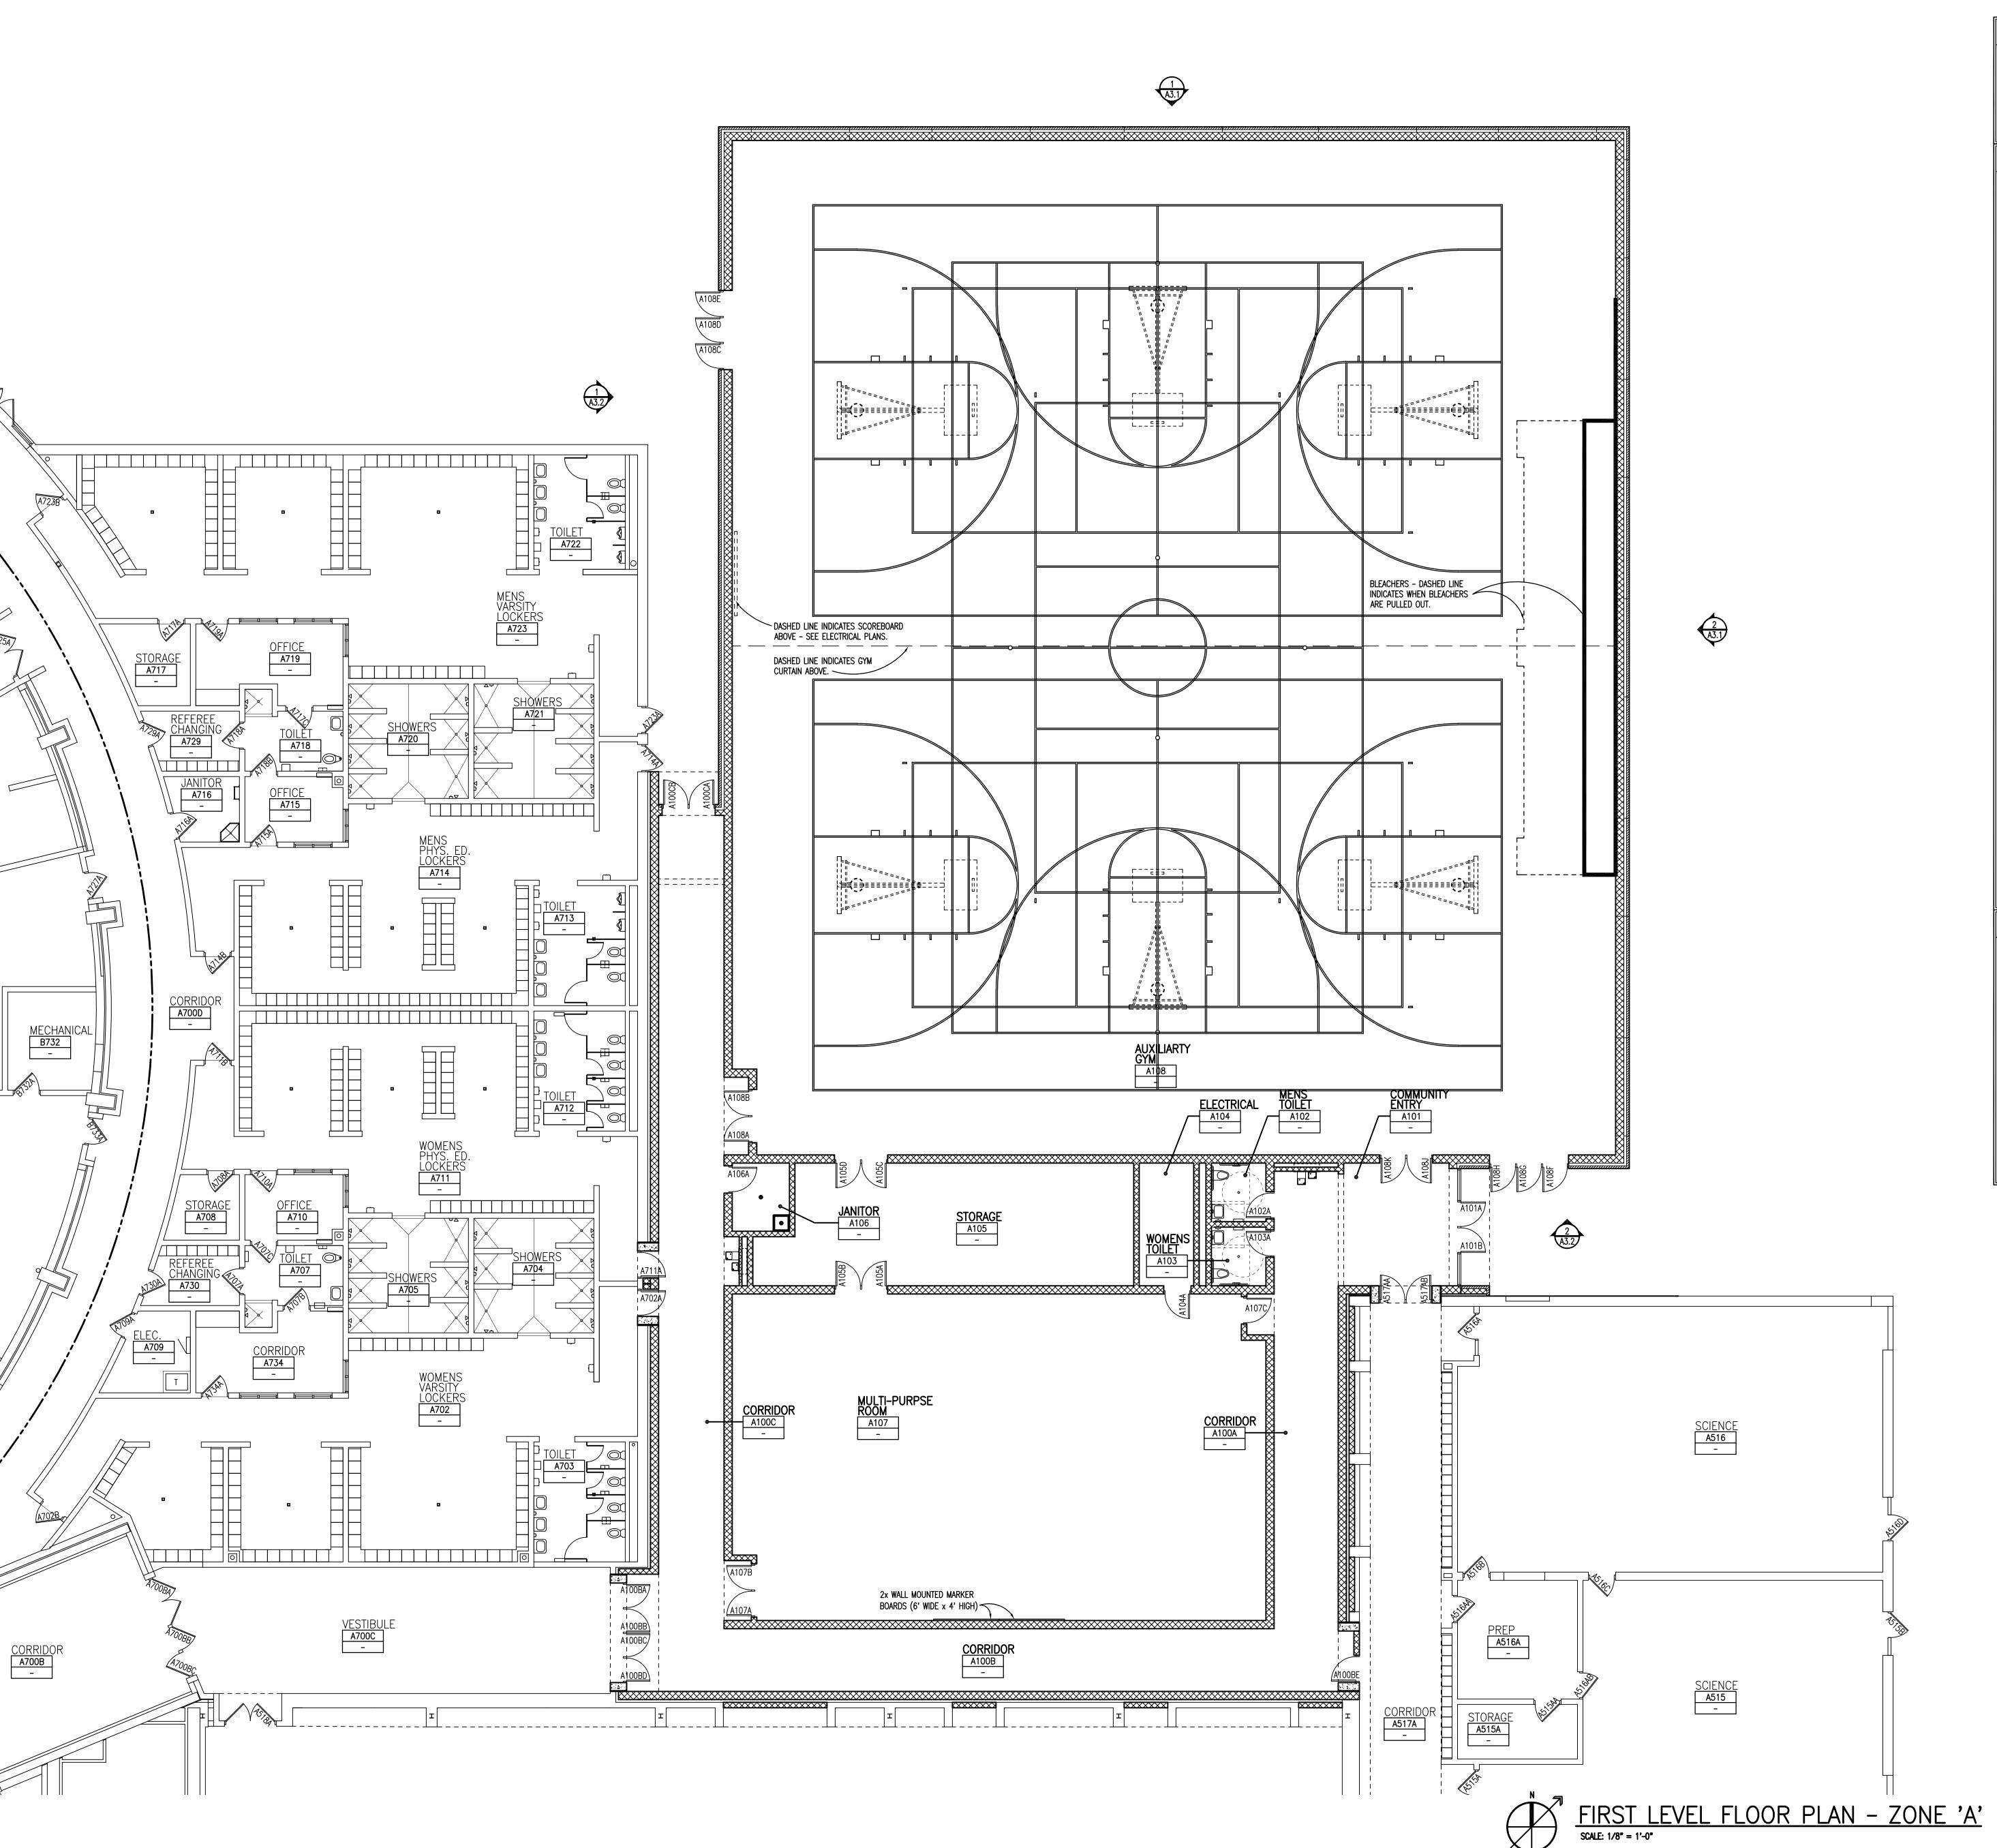GENERAL NOTES

- 1. COORDINATE SIZE AND LOCATION OF ALL CONCRETE HOUSEKEEPING PADS AND/OR EQUIPMENT SUPPORTS WITH APPROPRIATE EQUIPMENT MANUFACTURER.
- 2. COORDINATE SIZE AND LOCATION OF ALL ACCESS PANELS WITH TRADE REQUIRING THE SAME. ACCESS PANELS ARE SPECIFIED ARCHITECTURALLY BUT ARE REQUIRED TO BE PROVIDED BY EACH TRADE. ALL LOCATIONS MUST BE COORDINATED AND APPROVED BY THE ARCHITECT'S FIELD REPRESENTATIVE.
- 3. CONTRACTORS SHALL VERIFY ALL EXISTING BUILDING DIMENSIONS, PARTITION AND WALL LOCATIONS, AND FLOOR ELEVATIONS IN THE FIELD AND NOTIFY THE ARCHITECTS REPRESENTATIVE OF ANY DISCREPANCIES BEFORE START OF WORK.
- FLOOR PLANS ARE DIMENSIONED TO NOMINAL WALL THICKNESS TYPICAL.
 DIMENSIONS FOLLOWED BY ± SHOULD BE REVIEWED AND ALL NECESSARY ADJUSTMENTS MADE PRIOR TO FABRICATION AND/OR INSTALLATION OF AFFECTED WORK. NOTIFY ARCHITECTS REPRESENTATIVE IF DISCREPANCIES ARISE BEFORE PROCEEDING WITH THE WORK.
- 6. INSTALL CONTROL JOINTS IN GYPSUM BOARD AND METAL STUD-FRAMED PARTITIONS, WALLS, CEILINGS, BULKHEADS, FASCIAE AND SOFFITS IN COMPLIANCE WITH SPECIFICATIONS, AND WITH GENERAL REQUIREMENTS OF ASTM C840. PRIOR TO COMMENCEMENT OF FRAMING INSTALLATION SUBMIT COORDINATION DRAWINGS INDICATING PROPOSED LOCATIONS OF ALL CONTROL JOINTS, AS SPECIFIED.
- 7. PROVIDE CONTROL JOINTS WHERE INTERIOR CMU (ON SLAB) ABUTS EXTERIOR/INTERIOR MASONRY (ON FOUNDATIONS OR FOOTINGS).
- 8. VERIFY QUANTITY, SIZE, AND LOCATION OF ALL FLOOR, ROOF, AND WALL OPENINGS FOR MECHANICAL AND ELECTRICAL WORK WITH THE APPROPRIATE TRADE. PROVIDE ALL OPENINGS SHOWN OR REQUIRED FOR THE COMPLETION OF THE WORK. PROVIDE ALL LINTELS REQUIRED FOR THESE OPENINGS PER SPECIFICATIONS.
- REFER TO LIFE SAFETY PLANS FOR LOCATIONS OF REQUIRED FIRE RESISTANCE RATINGS. BECAUSE OF THE DRAWING SCALE OF THE LIFE SAFETY PLANS, COORDINATE THE REQUIRED FIRE RESISTANCE RATINGS WITH THOSE SHOWN ON THE REFLECTED CEILING PLANS.
- 10. REFER TO REFLECTED CEILING PLANS FOR EXTENSION OF PARTITION WALLS TO FLOOR OR ROOF CONSTRUCTION ABOVE AND WALL FIRE RESISTANCE RATING REQUIREMENTS.
- REFER TO STRUCTURAL DRAWINGS FOR ALL WIND FRAME LOCATIONS AT INTERIOR AND EXTERIOR WALLS.
 REFER TO A10._ SERIES DRAWINGS FOR FLOOR FINISH PATTERNS AND ROOM
- FINISHES.

 13. REFER TO STRUCTURAL DRAWINGS FOR ORIENTATION AND SIZES OF ALL
- STRUCTURAL COLUMNS.

 14. REFER TO DRAWING A8.1 FOR TYPICAL DETAILS PERTAINING TO WALL
- TERMINATIONS AT STRUCTURE ABOVE AND MASONRY CONTROL JOINT DETAILS.

 15. VERIFY ALL DIMENSIONS IN FIELD.
- 16. PROVIDE WOOD BLOCKING WITHIN STUD WALLS FOR WALL MOUNTED ITEMS i.e. GRAB BARS, TOWEL DISPENSERS, PENCIL SHARPENERS, WALL STOPS, ACCORDIAN PARTITION JAMBS, ETC. REFER ALSO TO A9._ SERIES AND A6._
- 17. REFER TO EXTERIOR ELEVATIONS AND PLAN DETAILS FOR LOCATIONS OF CONTROL JOINTS IN EXTERIOR WALLS.
- 18. WHERE SLAB DEPRESSIONS ARE INDICATED FOR WOOD FLOOR SYSTEMS, CONFIRM DEPRESSION WITH WOOD FLOORING CONTRACTOR. ADJUST DEPRESSION, AS REQUIRED, TO MEET FLUSH WITH ADJACENT FLOOR MATERIALS (i.e. CERAMIC TILE, QUARRY TILE, ETC.).

PATCHING NOTES

OTHER OPENINGS.

- REFER TO DEMOLITION PLANS FOR ADDITIONAL PATCHING NOTES.
- 2. FOR ALL FLOOR SURFACES RECEIVING NEW FLOOR FINISHES, PREPARE SUBSTRATE BY PROVIDING LEVELING AND PATCHING COMPOUNDS RECOMMENDED BY FINISH FLOORING MANUFACTURERS. CONTRACTOR'S BASE BID PROPOSAL SHALL ASSUME THAT ALL AREAS, INDICATED TO RECEIVE NEW FINISHES, WILL REQUIRE FLOOR PREPARATION.
- 3. PATCH AND REPAIR ALL FLOOR AND WALL SURFACES LEFT DAMAGED OR INCOMPLETE FROM REMOVAL OF EXISTING PARTITIONS, MILLWORK, CASEWORK, CHALKBOARDS, TACKBOARDS, DISPLAY CASES OR OTHER FIXED EQUIPMENT WITH MATERIALS TO MATCH EXISTING, AS ACCEPTABLE TO THE ARCHITECT.
- 4. MATCH EXISTING MASONRY COURSING ADJACENT IN EACH AREA AND TOOTH NEW WORK INTO EXISTING, UNLESS OTHERWISE INDICATED.
- 5. AT EXISTING FLOOR FINISHES TO REMAIN, THAT BECOME SUBSTRATES FOR NEW
- FLOOR FINISHES, PATCH AND FILL EXISTING AS REQUIRED TO PREPARE FOR NEW FLOOR FINISH UNTIL ACCEPTABLE TO NEW FLOOR FINISH CONTRACTOR.

 TOOTH-IN MASONRY INTO EXISTING, U.O.N., INCLUDING JAMBS OF DOOR AND

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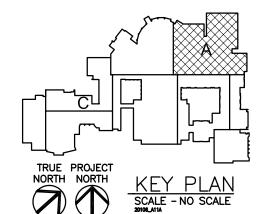
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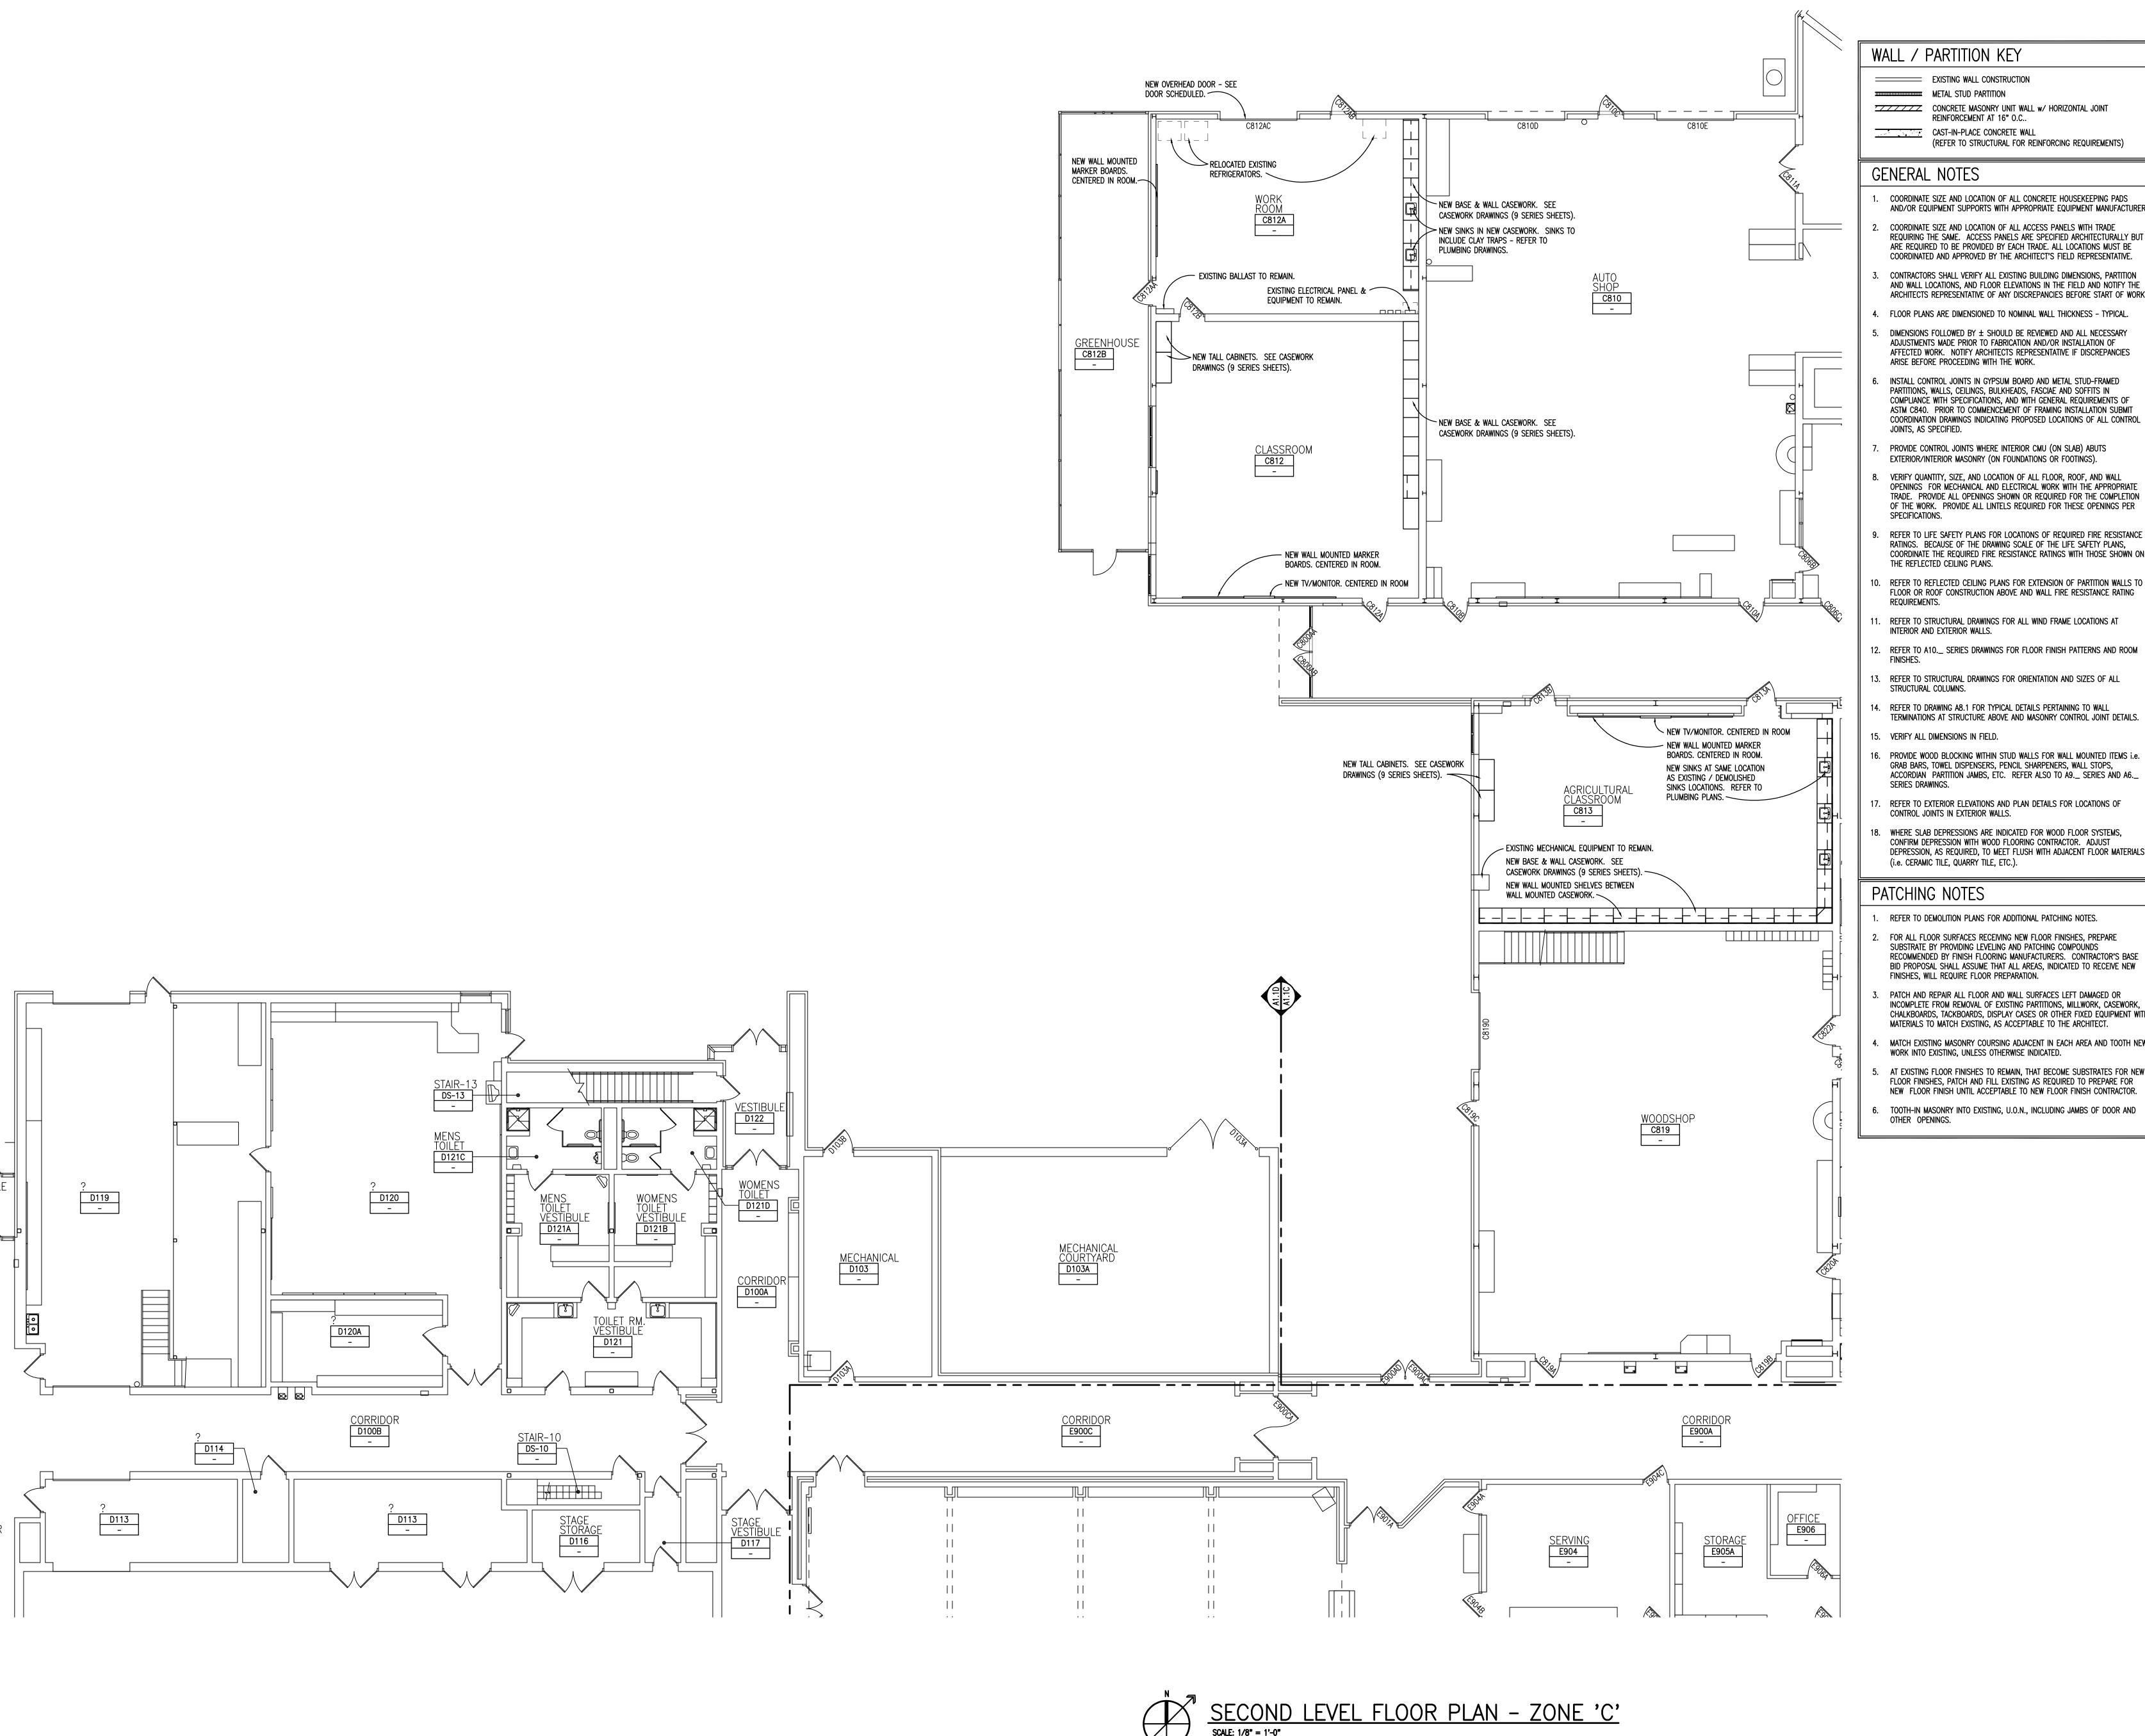
Charlotte Public Schools

First Level
Floor Plan - Zone 'A'



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WALL / PARTITION KEY

METAL STUD PARTITION CONCRETE MASONRY UNIT WALL w/ HORIZONTAL JOINT

REINFORCEMENT AT 16" O.C..

CAST-IN-PLACE CONCRETE WALL (REFER TO STRUCTURAL FOR REINFORCING REQUIREMENTS)

GENERAL NOTES

COORDINATE SIZE AND LOCATION OF ALL CONCRETE HOUSEKEEPING PADS AND/OR EQUIPMENT SUPPORTS WITH APPROPRIATE EQUIPMENT MANUFACTURER.

COORDINATE SIZE AND LOCATION OF ALL ACCESS PANELS WITH TRADE REQUIRING THE SAME. ACCESS PANELS ARE SPECIFIED ARCHITECTURALLY BUT ARE REQUIRED TO BE PROVIDED BY EACH TRADE. ALL LOCATIONS MUST BE COORDINATED AND APPROVED BY THE ARCHITECT'S FIELD REPRESENTATIVE.

CONTRACTORS SHALL VERIFY ALL EXISTING BUILDING DIMENSIONS, PARTITION AND WALL LOCATIONS, AND FLOOR ELEVATIONS IN THE FIELD AND NOTIFY THE ARCHITECTS REPRESENTATIVE OF ANY DISCREPANCIES BEFORE START OF WORK.

FLOOR PLANS ARE DIMENSIONED TO NOMINAL WALL THICKNESS - TYPICAL. DIMENSIONS FOLLOWED BY ± SHOULD BE REVIEWED AND ALL NECESSARY ADJUSTMENTS MADE PRIOR TO FABRICATION AND/OR INSTALLATION OF AFFECTED WORK. NOTIFY ARCHITECTS REPRESENTATIVE IF DISCREPANCIES ARISE BEFORE PROCEEDING WITH THE WORK.

INSTALL CONTROL JOINTS IN GYPSUM BOARD AND METAL STUD-FRAMED PARTITIONS, WALLS, CEILINGS, BULKHEADS, FASCIAE AND SOFFITS IN COMPLIANCE WITH SPECIFICATIONS, AND WITH GENERAL REQUIREMENTS OF ASTM C840. PRIOR TO COMMENCEMENT OF FRAMING INSTALLATION SUBMIT COORDINATION DRAWINGS INDICATING PROPOSED LOCATIONS OF ALL CONTROL JOINTS, AS SPECIFIED.

PROVIDE CONTROL JOINTS WHERE INTERIOR CMU (ON SLAB) ABUTS EXTERIOR/INTERIOR MASONRY (ON FOUNDATIONS OR FOOTINGS).

VERIFY QUANTITY, SIZE, AND LOCATION OF ALL FLOOR, ROOF, AND WALL OPENINGS FOR MECHANICAL AND ELECTRICAL WORK WITH THE APPROPRIATE TRADE. PROVIDE ALL OPENINGS SHOWN OR REQUIRED FOR THE COMPLETION OF THE WORK. PROVIDE ALL LINTELS REQUIRED FOR THESE OPENINGS PER SPECIFICATIONS.

REFER TO LIFE SAFETY PLANS FOR LOCATIONS OF REQUIRED FIRE RESISTANCE RATINGS. BECAUSE OF THE DRAWING SCALE OF THE LIFE SAFETY PLANS, COORDINATE THE REQUIRED FIRE RESISTANCE RATINGS WITH THOSE SHOWN ON THE REFLECTED CEILING PLANS.

REFER TO REFLECTED CEILING PLANS FOR EXTENSION OF PARTITION WALLS TO FLOOR OR ROOF CONSTRUCTION ABOVE AND WALL FIRE RESISTANCE RATING

REFER TO STRUCTURAL DRAWINGS FOR ALL WIND FRAME LOCATIONS AT INTERIOR AND EXTERIOR WALLS.

13. REFER TO STRUCTURAL DRAWINGS FOR ORIENTATION AND SIZES OF ALL STRUCTURAL COLUMNS.

REFER TO DRAWING A8.1 FOR TYPICAL DETAILS PERTAINING TO WALL TERMINATIONS AT STRUCTURE ABOVE AND MASONRY CONTROL JOINT DETAILS.

15. VERIFY ALL DIMENSIONS IN FIELD.

PROVIDE WOOD BLOCKING WITHIN STUD WALLS FOR WALL MOUNTED ITEMS i.e. GRAB BARS, TOWEL DISPENSERS, PENCIL SHARPENERS, WALL STOPS, ACCORDIAN PARTITION JAMBS, ETC. REFER ALSO TO A9._ SERIES AND A6._

REFER TO EXTERIOR ELEVATIONS AND PLAN DETAILS FOR LOCATIONS OF CONTROL JOINTS IN EXTERIOR WALLS.

WHERE SLAB DEPRESSIONS ARE INDICATED FOR WOOD FLOOR SYSTEMS, CONFIRM DEPRESSION WITH WOOD FLOORING CONTRACTOR. ADJUST DEPRESSION, AS REQUIRED, TO MEET FLUSH WITH ADJACENT FLOOR MATERIALS (i.e. CERAMIC TILE, QUARRY TILE, ETC.).

PATCHING NOTES

REFER TO DEMOLITION PLANS FOR ADDITIONAL PATCHING NOTES.

FOR ALL FLOOR SURFACES RECEIVING NEW FLOOR FINISHES, PREPARE SUBSTRATE BY PROVIDING LEVELING AND PATCHING COMPOUNDS RECOMMENDED BY FINISH FLOORING MANUFACTURERS. CONTRACTOR'S BASE BID PROPOSAL SHALL ASSUME THAT ALL AREAS, INDICATED TO RECEIVE NEW FINISHES, WILL REQUIRE FLOOR PREPARATION.

PATCH AND REPAIR ALL FLOOR AND WALL SURFACES LEFT DAMAGED OR INCOMPLETE FROM REMOVAL OF EXISTING PARTITIONS, MILLWORK, CASEWORK, CHALKBOARDS, TACKBOARDS, DISPLAY CASES OR OTHER FIXED EQUIPMENT WITH MATERIALS TO MATCH EXISTING, AS ACCEPTABLE TO THE ARCHITECT.

MATCH EXISTING MASONRY COURSING ADJACENT IN EACH AREA AND TOOTH NEW WORK INTO EXISTING, UNLESS OTHERWISE INDICATED. AT EXISTING FLOOR FINISHES TO REMAIN, THAT BECOME SUBSTRATES FOR NEW

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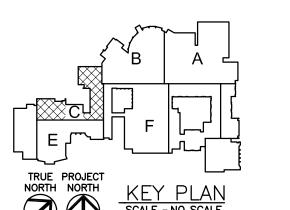
REGISTRATION SEAL

CONSULTANT

PROJECT TITLE Charlotte High School Addition & Remodeling

Charlotte Public Schools

DRAWING TITLE Second Level Floor Plan - Zone 'C'



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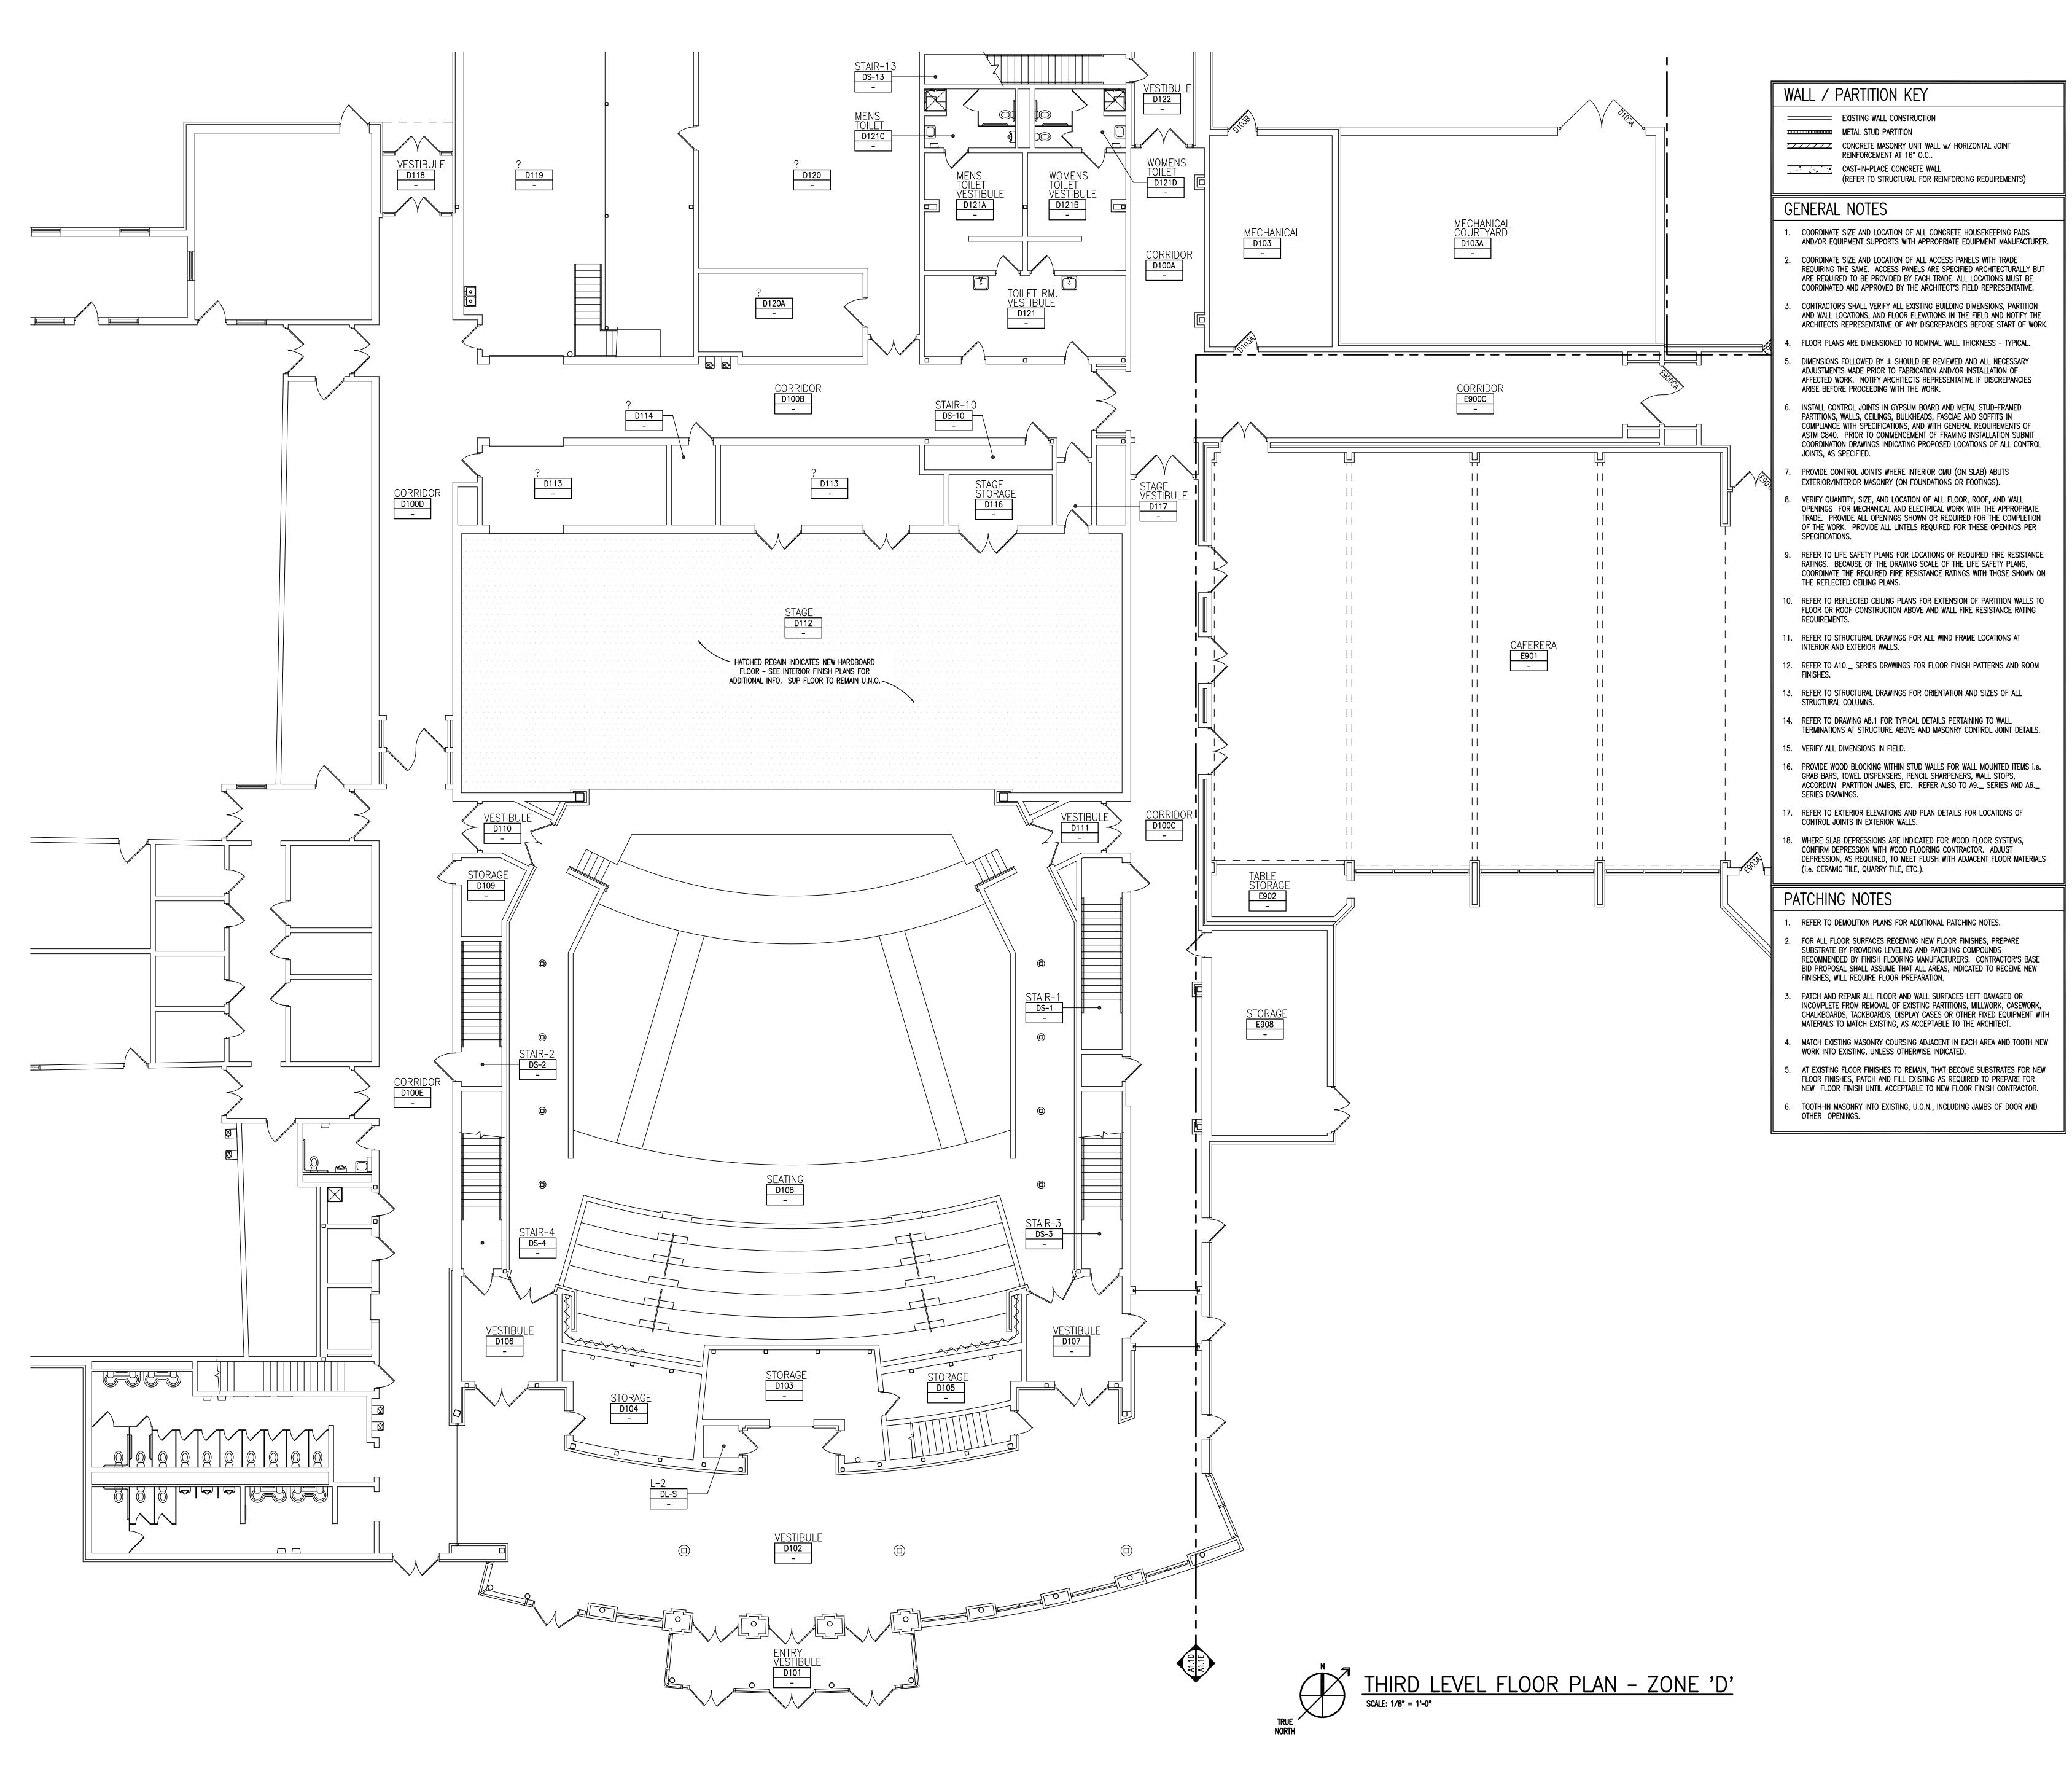
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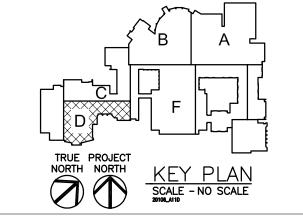
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Third Level
Floor Plan - Zone 'D'



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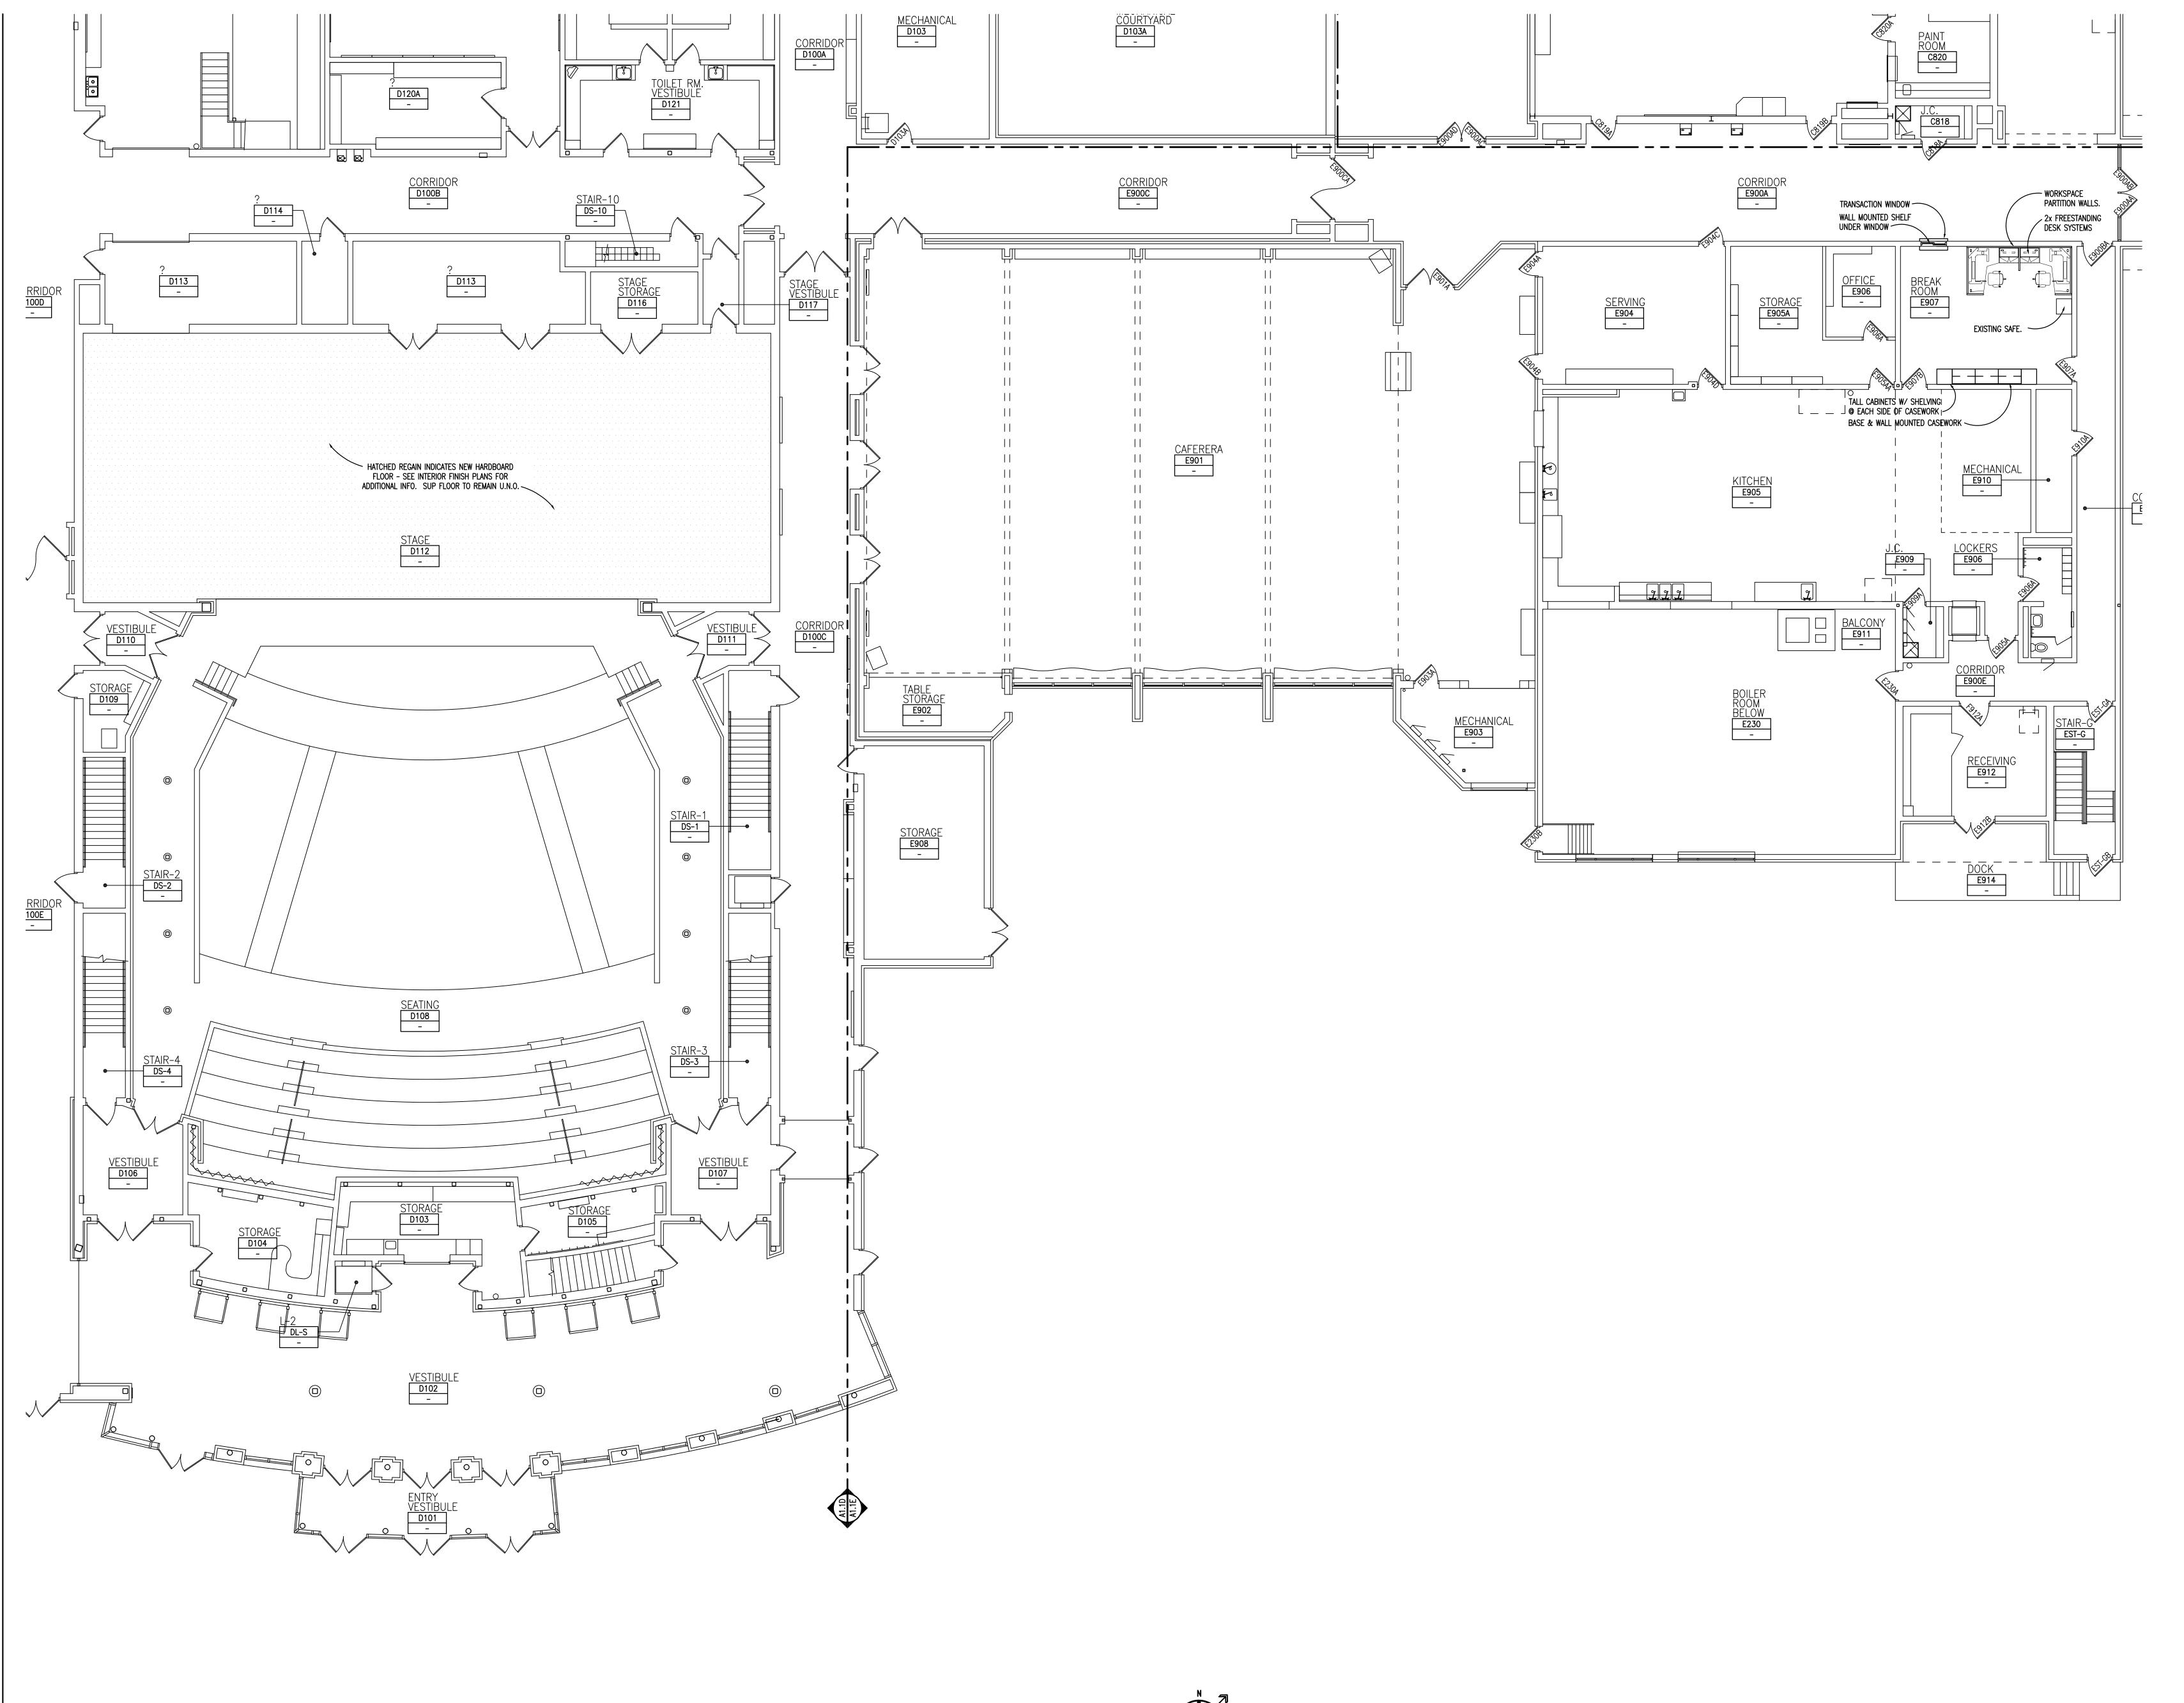
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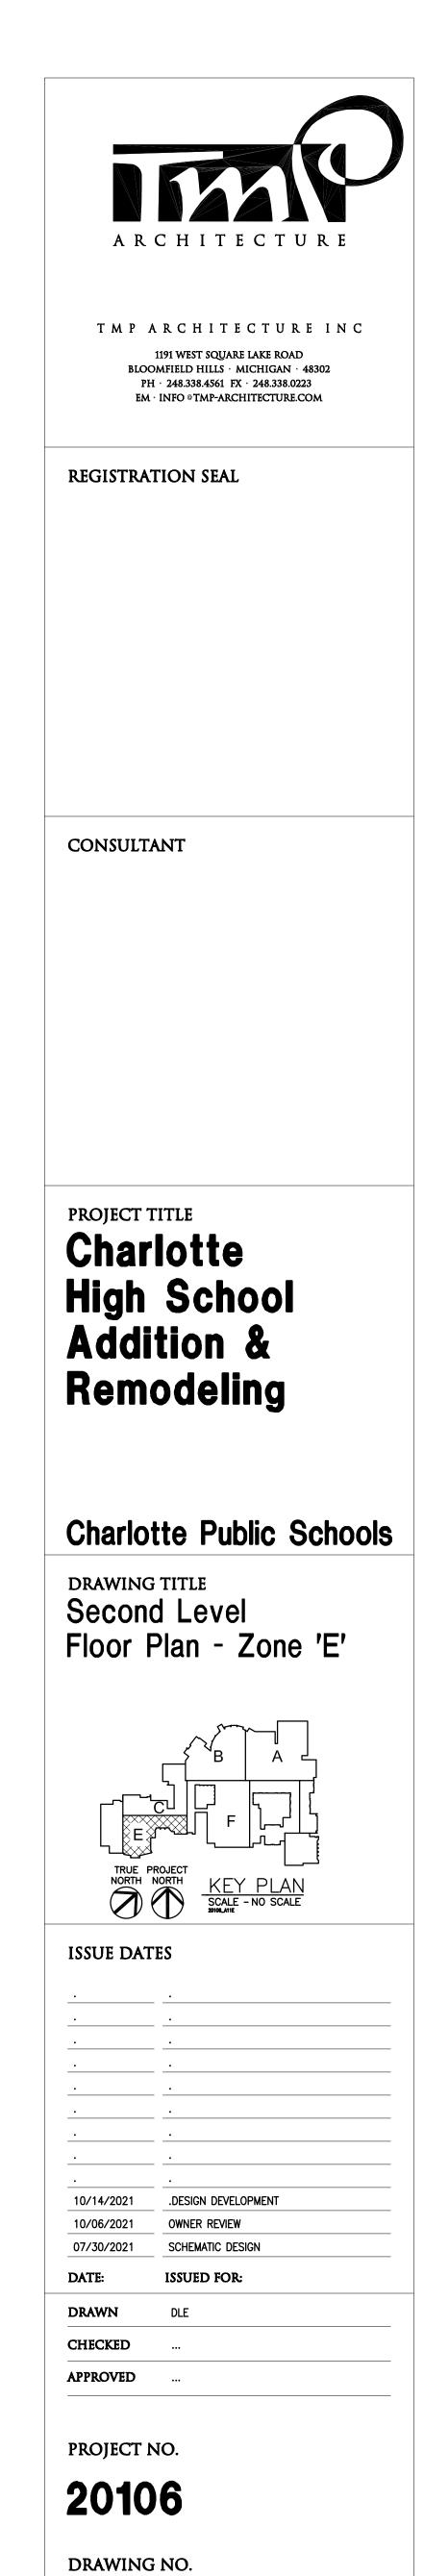
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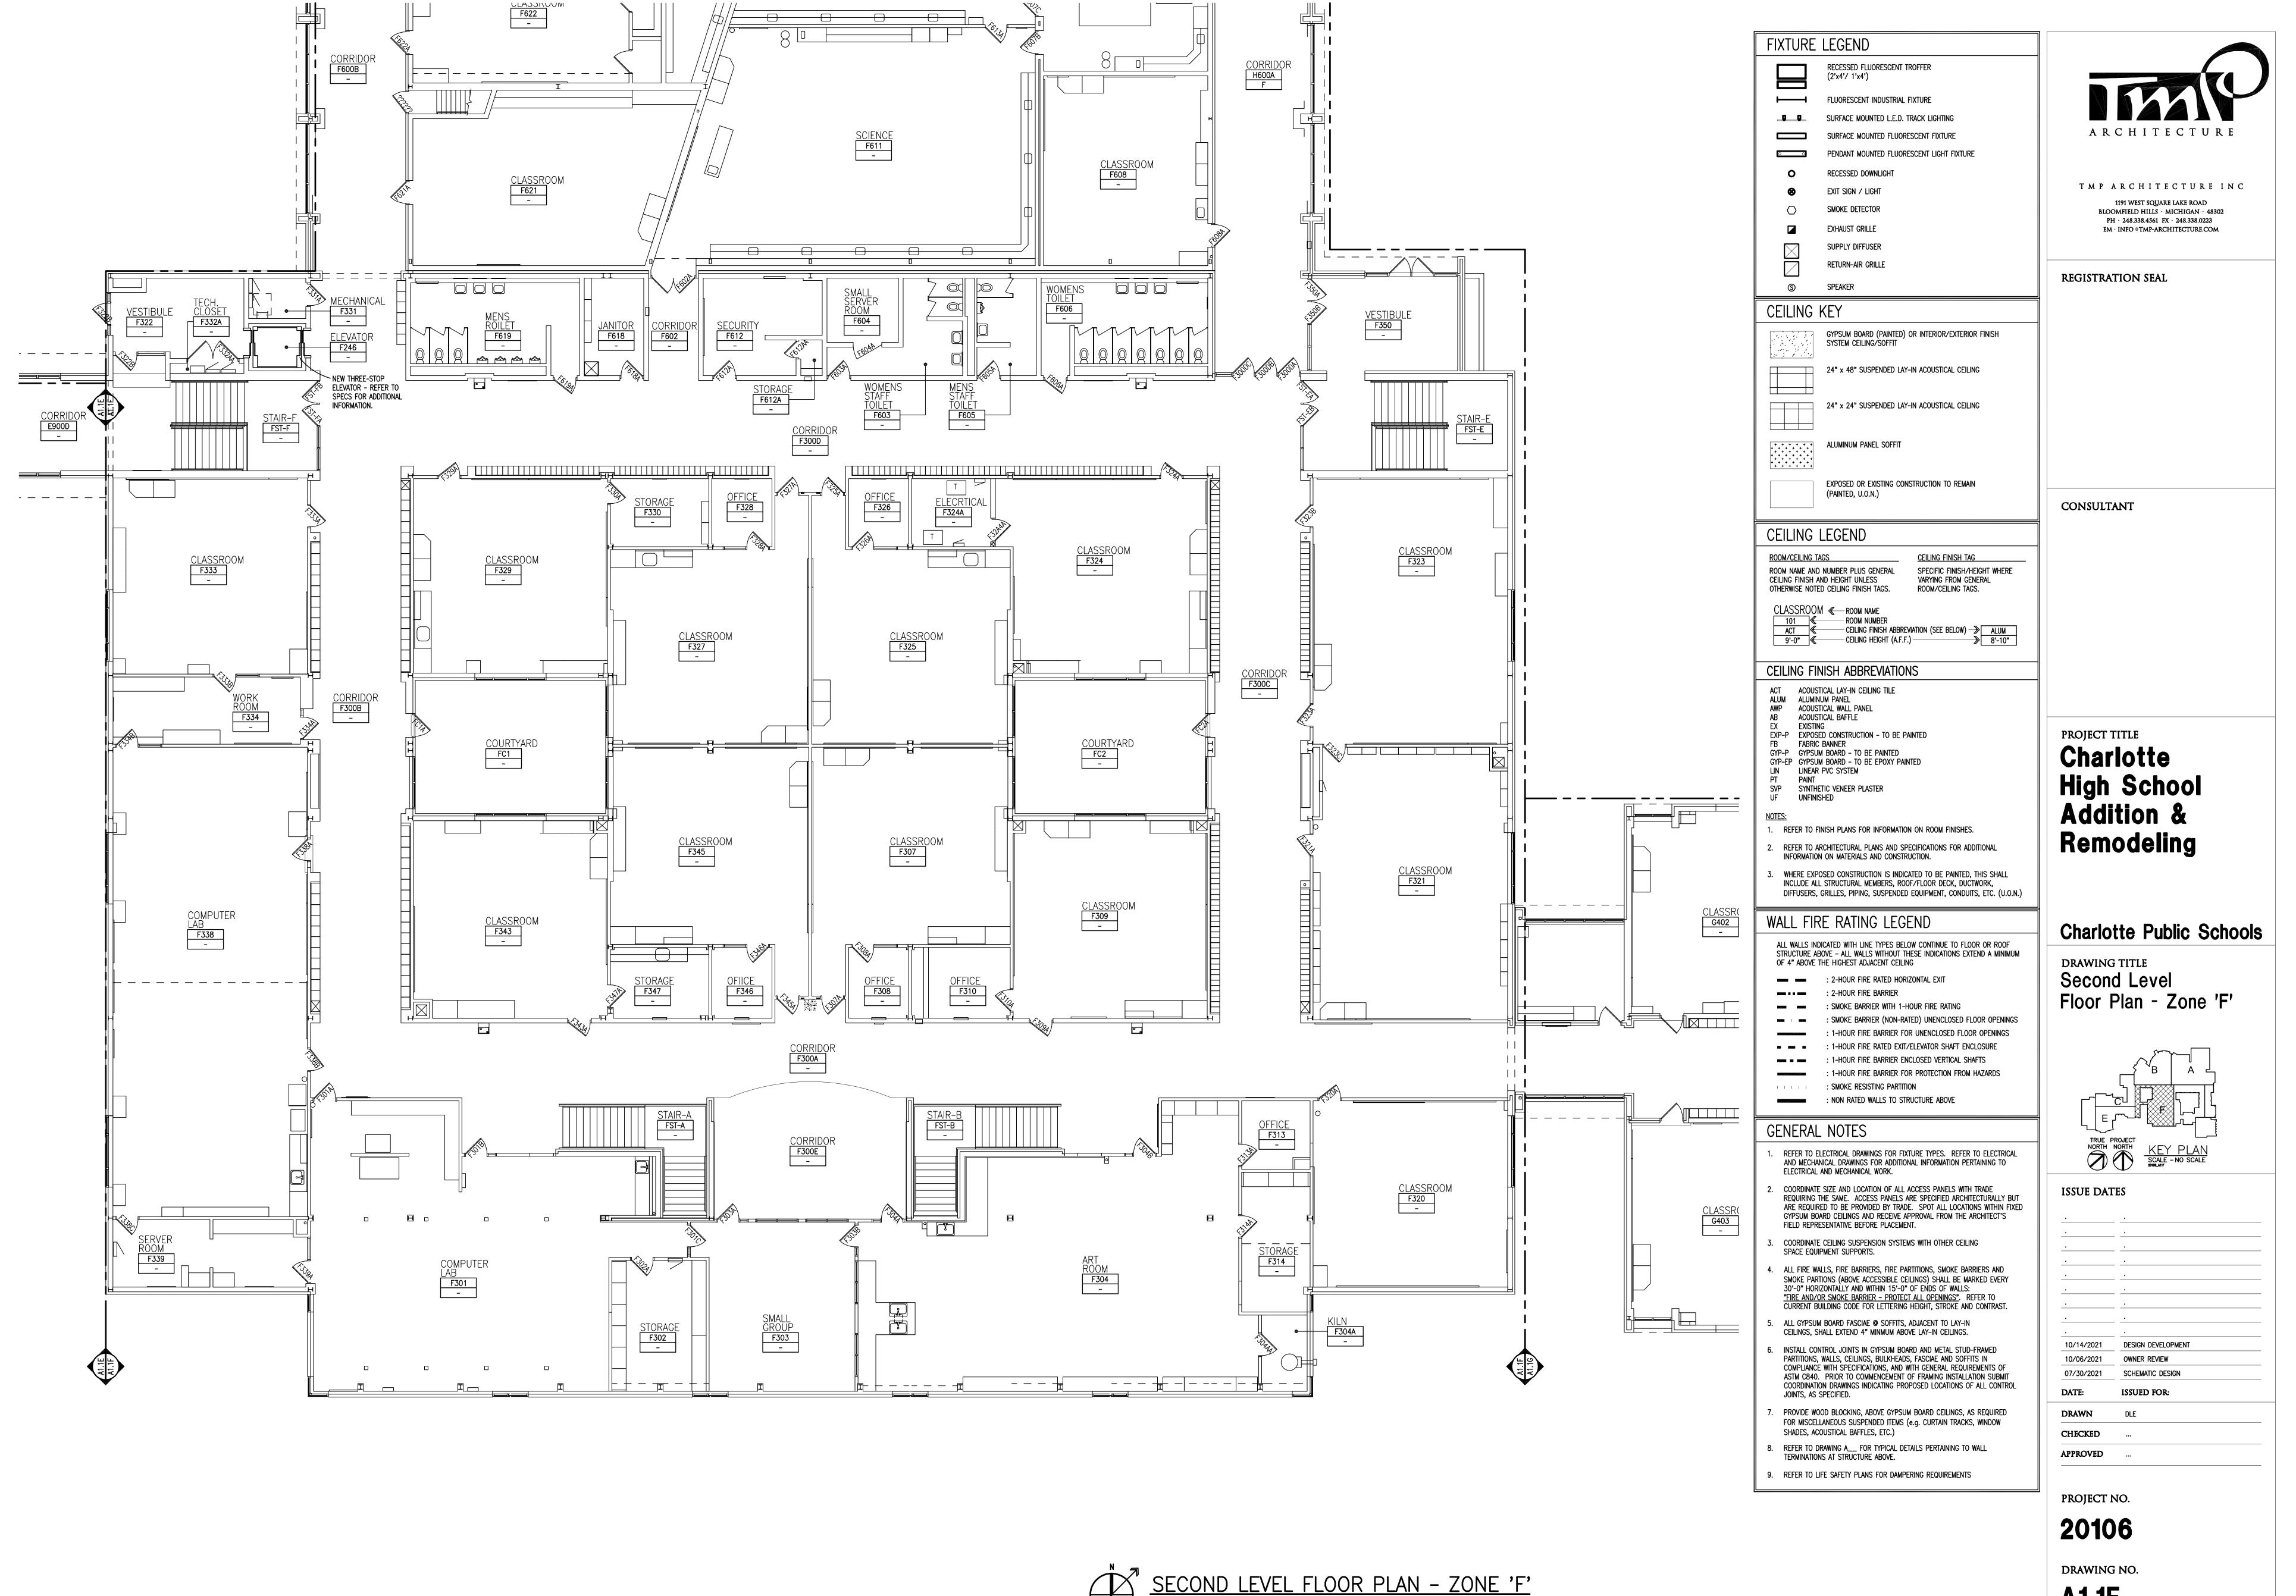


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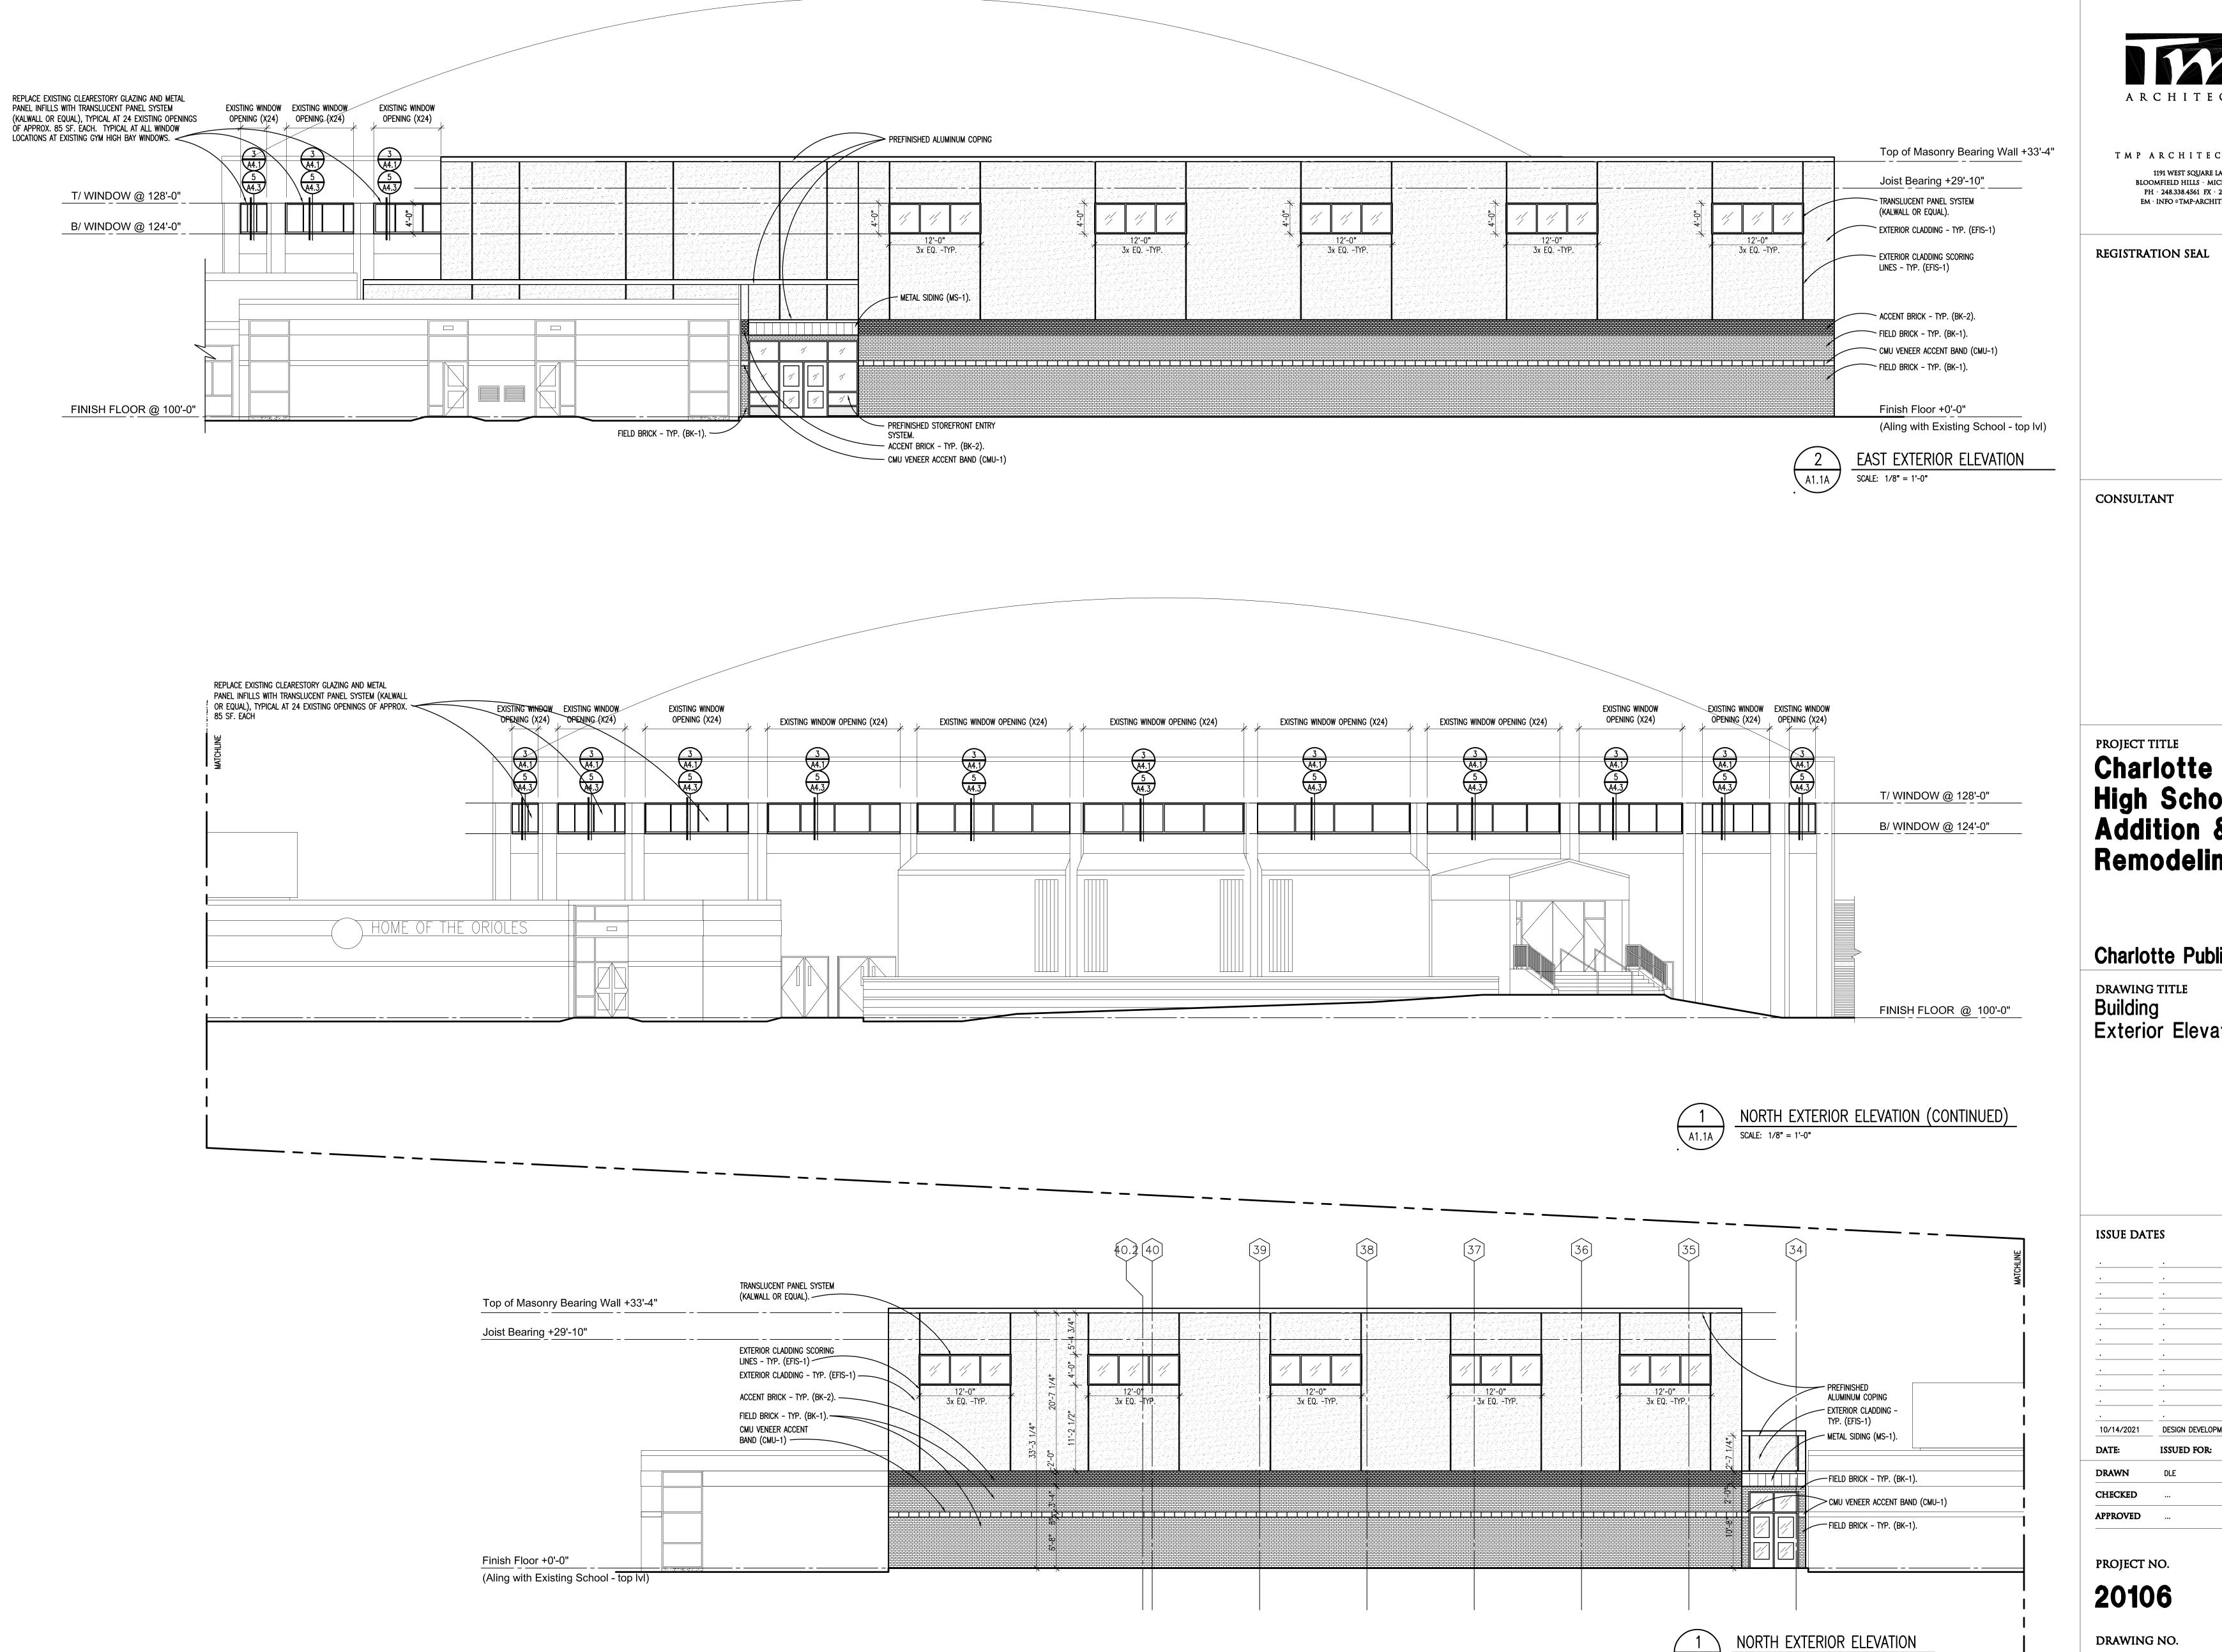
SECOND LEVEL FLOOR PLAN - ZONE 'E'

SCALE: 1/8" = 1'-0"



SECOND LEVEL FLOOR PLAN - ZONE 'F'
SCALE: 1/8" = 1'-0"

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High School Addition & Remodeling

Charlotte Public Schools


Exterior Elevations


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REGISTRATION SEAL

CONSULTANT

PROJECT TITLE Charlotte High School Addition & Remodeling

Charlotte Public Schools

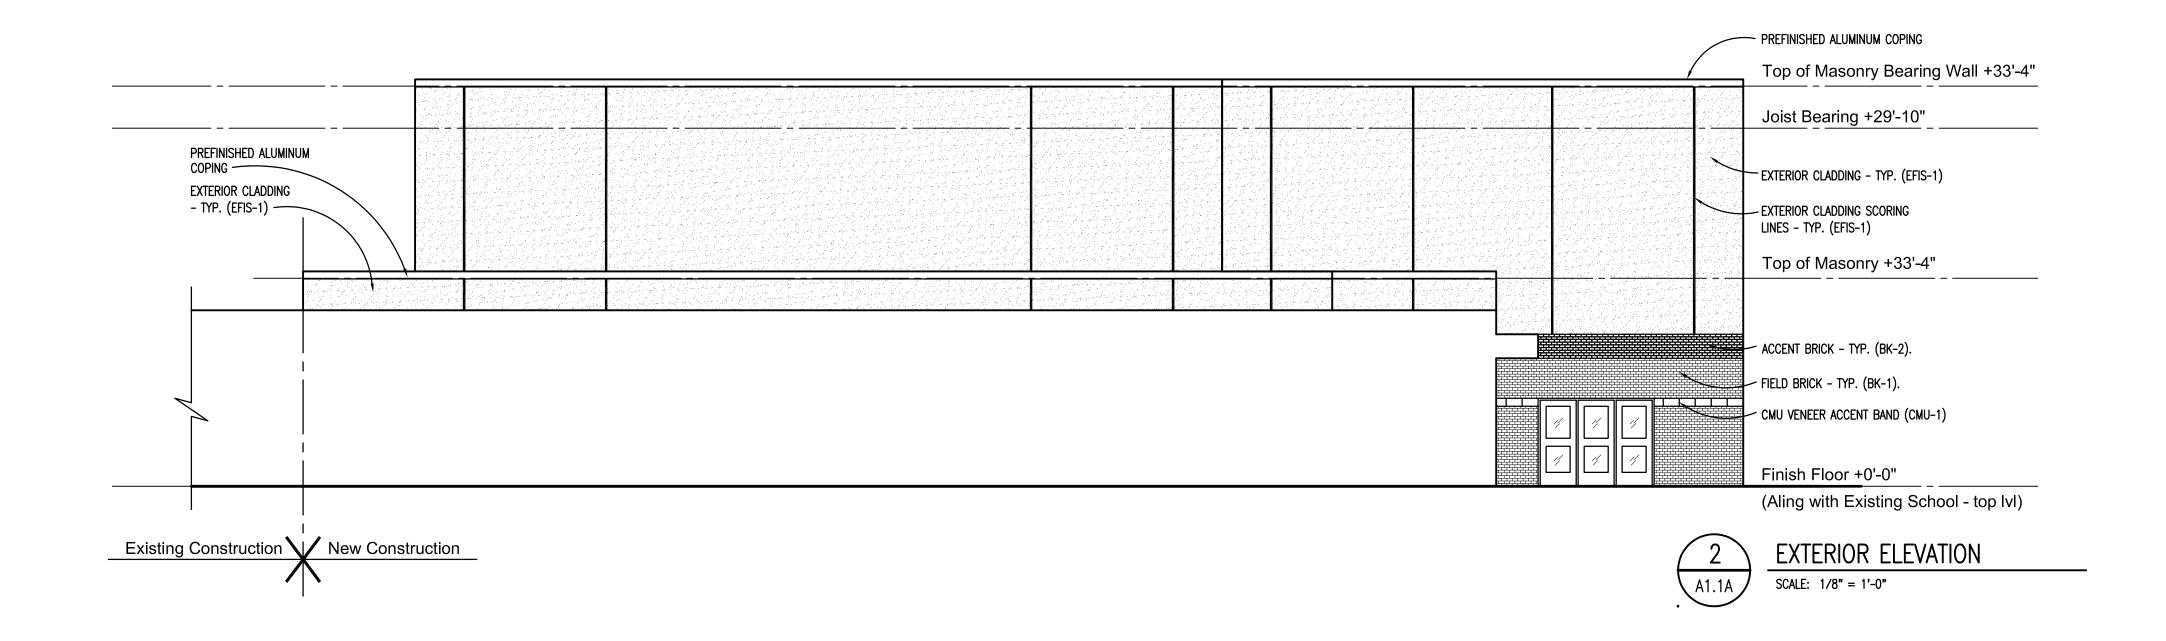DRAWING TITLE Building **Exterior Elevations**

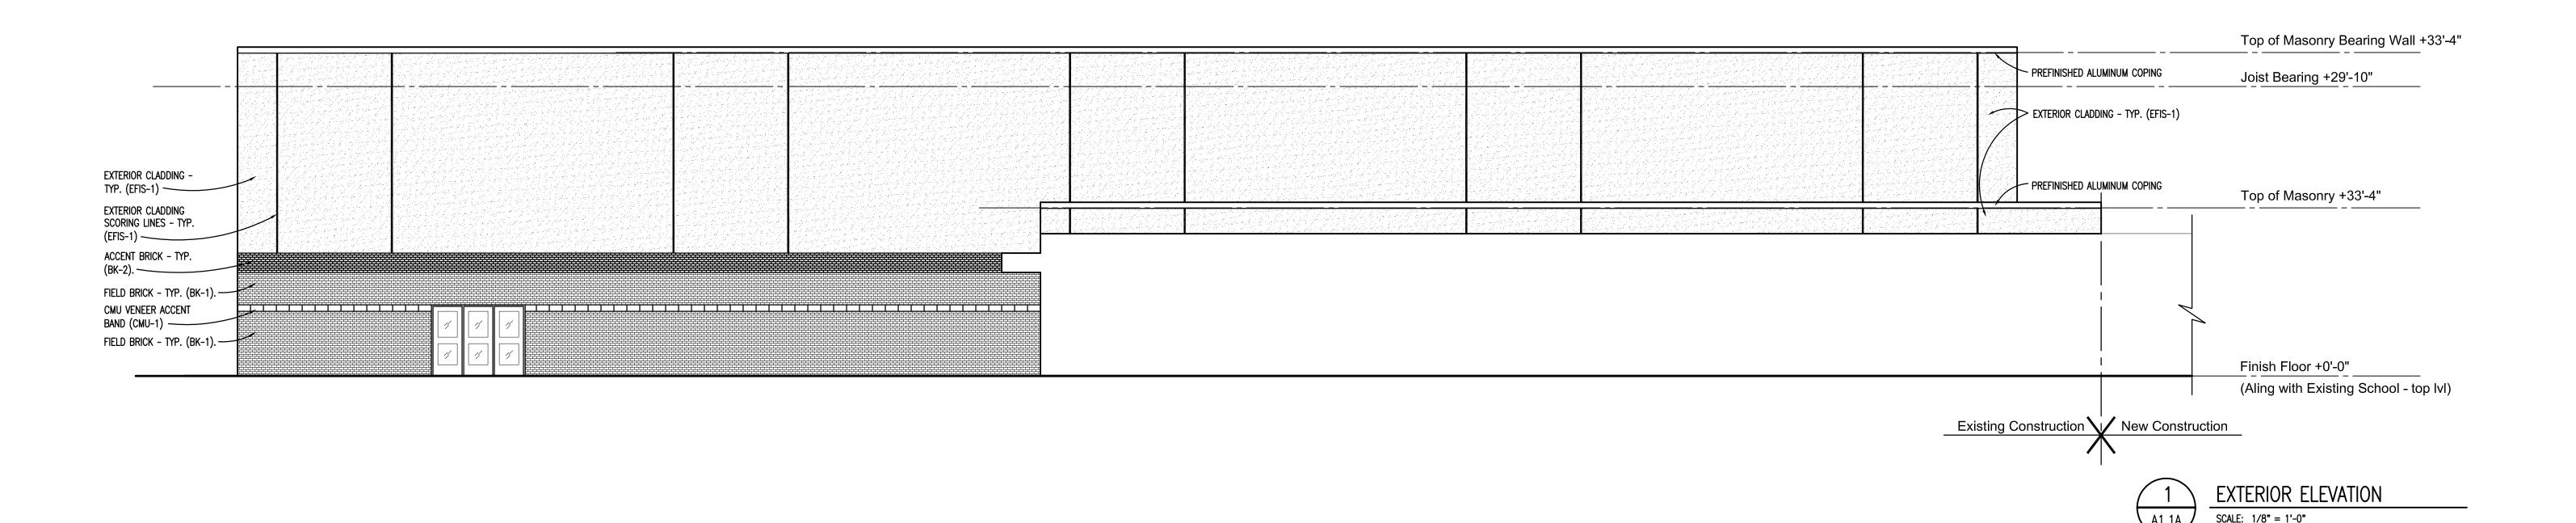
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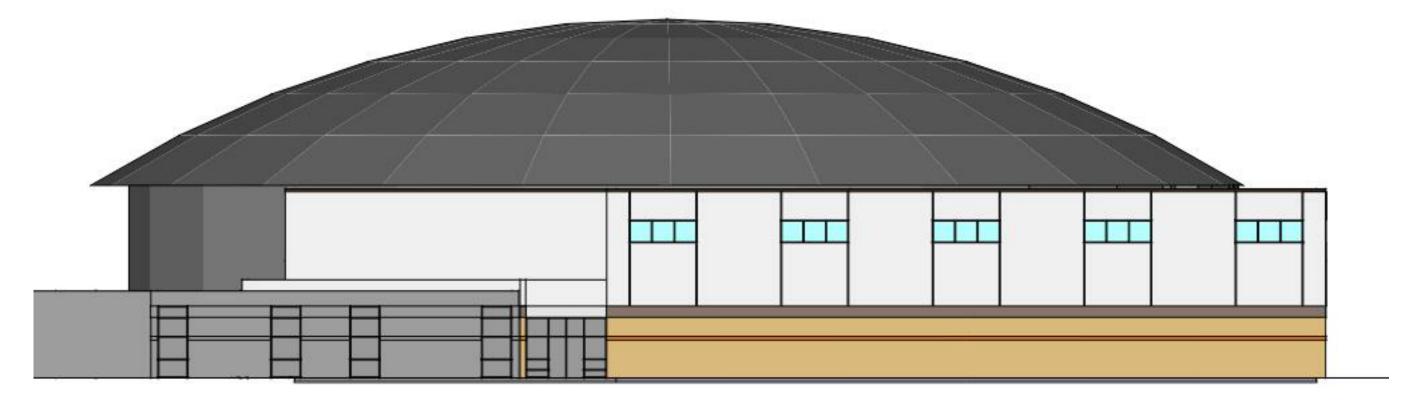
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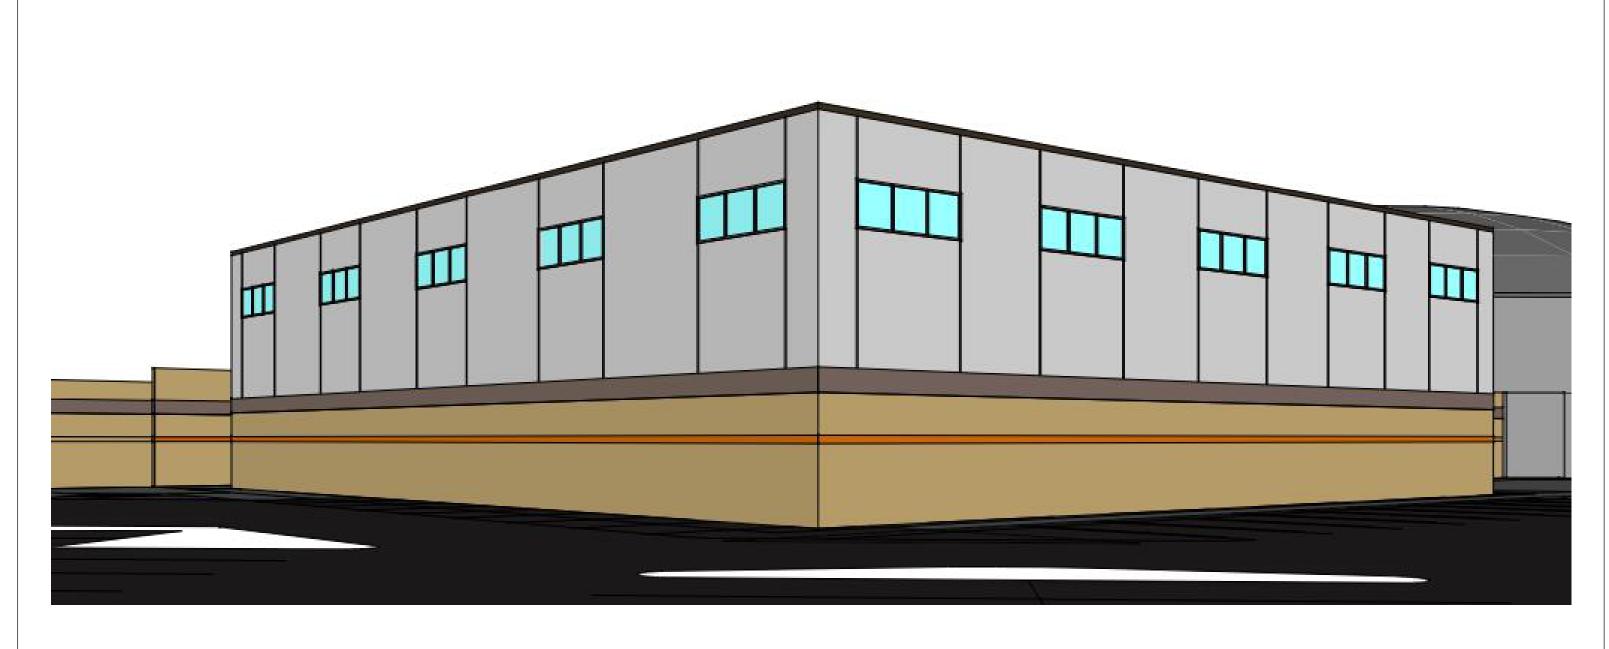
EXTERIOR ELEVATION



EXTERIOR ELEVATION

CHARLOTTE - HIGH SCHOOL ADDITION




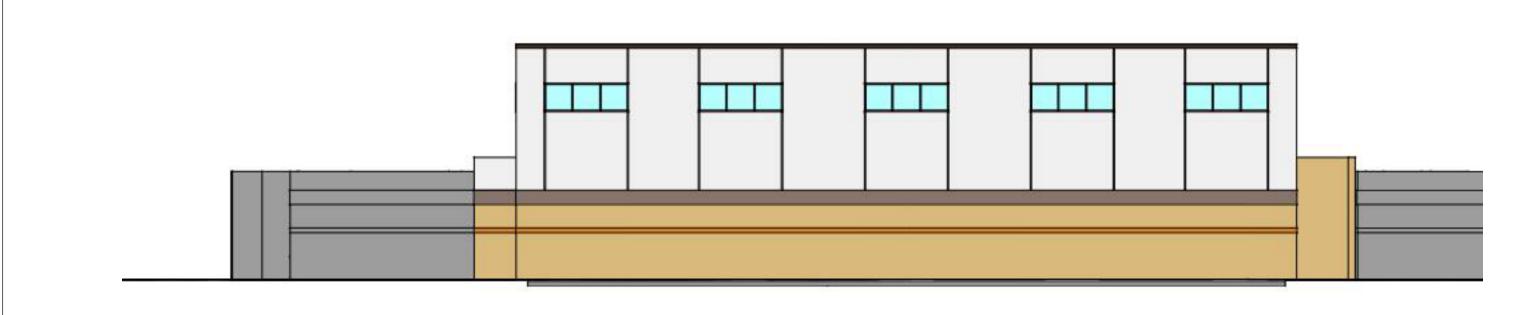

EXTERIOR PERSPECTIVE

CHARLOTTE - HIGH SCHOOL ADDITION



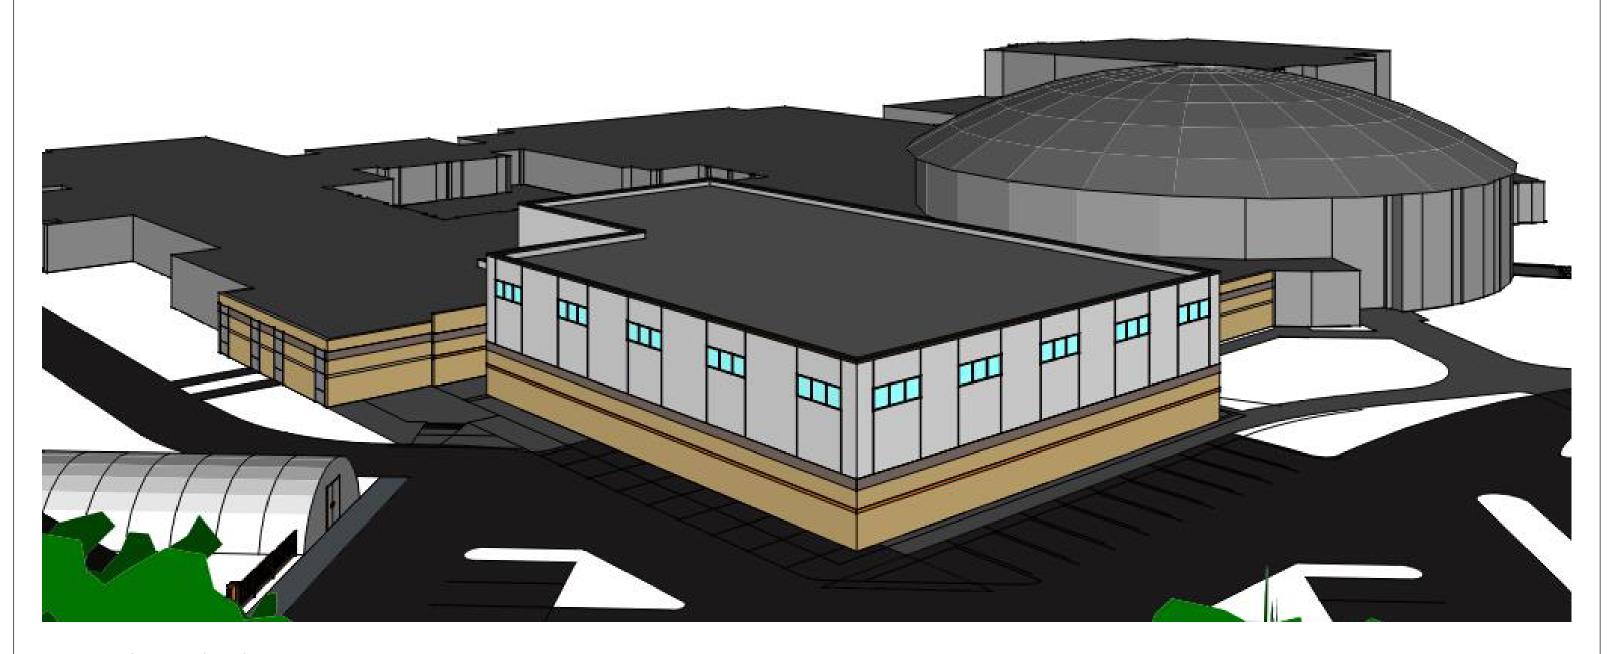

EXTERIOR PERSPECTIVE

CHARLOTTE - HIGH SCHOOL ADDITION







Charlotte Public Schools 2020 Bond Program

Phase II Subcommittee Review - 12.09.2021

Charlotte Public Schools - 2020 Bond Program



Phase II Project Timeline

2021						2022				<u> </u>	-,	2023											
December	January	February	March	April	May	June	July A	august September	October	November	December	January	February	March	April	May	June	July	August	September	October	November	December
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Charlotte Public Schools 2020 Bond Program Phase II Design Development Estimate



12/9/2021

SCHOOL	SITE	RENO	ADDITION	NON-ITEMIZED	POST-VE TOTAL	BOND BUDGET	VARIANCE	% VARIANCE
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WECC	\$163,021	\$0	\$0	\$57,752	\$220,773	\$370,584	\$149,811	40.4%
GALEWOOD	\$661,895	\$1,444,500	\$3,780,617	\$9,628	\$5,229,952	\$5,346,733	\$116,781	2.2%
Esser Funds				(\$584,718)				
Generator-Owner Direct				(\$81,970)				
WASHINGTON	\$249,911	\$595,841	\$2,292,780	\$213,959	\$3,352,491	\$2,976,272	(\$376,219)	-11.2%
HIGH SCHOOL	\$1,195,584	\$2,693,113	\$5,127,166	\$80,029	\$9,038,892	\$8,791,530	(\$247,362)	-2.7%
MDE Funding				(\$57,000)				
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TOTAL	\$2,270,411	\$4,733,454	\$11,200,563	(\$362,320)	\$17,842,108	\$17,485,119	(\$356,989)	-2.0%

*Excludes Owner Costs and Soft Costs